Hamtramck Public Schools Kosciuszko Middle School Structural Repairs Addendum # 1 December 6, 2022 Page 1 of 1

ADDENDUM

Project Name: Hamtramck Public Schools Addendum No: One (1)

Kosciuszko Middle School Structural Repairs

Structural Repairs

Project Number: 21-167 Issue Date: December 6, 2022

Project Location: Hamtramck, Michigan

This Addendum forms a part of the above described Contract Documents and supersedes, supplements or clarifies parts thereof to the extent defined by the terms set forth in this Addendum.

This addendum consists of (2) typed pages and the following attachment:

Drawings: Sheets: A1-01, A1-02, A3-01, A3-02, A6-01, S201, S202, S300, S301, MED2-01 AND ME2-01.

ARCHITECTURAL DRAWINGS:

ITEM A1 Drawing A1-01 – Lower Level Demolition Plan (Revised and reissued)

- A. Relocated new opening to align with existing door.
- B. Added dimension clarifying size of east side demolition.
- C. Removed keynote 25, regarding cleaning and painting steel, and replaced with note regarding existing concrete deck surfaces.

ITEM A2 Drawing A1-02 – Upper Level Demolition Plan and Elevation (Revised and reissued)

- A. Reworded keynote 8 for clarification.
- B. Removed trenching location for gas line and associated keynote 14A to remove duplicate information on the drawings. See mechanical drawings for gas line work.

ITEM A3 Drawing A3-01 – Lower Level Floor Plan (Revised and reissued)

- A. Updated location of new access hatch into Storage 101.
- B. Removed premanufactured metal steps in Storage 101, and associated keynote 2.
- C. Replaced keynote 2 with note for engineered fill, and located tags on east and west side of existing construction to remain.
- D. Modified wording of keynote 20 to better describe surfaces to receive waterproofing.

ITEM A4 Drawing A3-02 – Upper Level Floor Plan (Revised and reissued)

- A. Updated keynote E8 for clarification of engineered fill required.
- B. Updated keynote 12.
- C. Modified leaders on elevation 2.

ITEM A4 Drawing A6-01 – Wall Sections (Revised and reissued)

- A. Modified note on all sections clarifying need to scrape existing ceiling clean for proper securing of channels.
- B. Added end panel at new ceiling deck on section 3.

Hamtramck Public Schools Kosciuszko Middle School Structural Repairs Addendum # 1 December 6, 2022 Page 2 of 1

STRUCTURAL DRAWINGS:

ITEM S1 Drawing S201 – Partial Foundation Plan (Revised and reissued)

A. Revised concrete extension at the north side.

B. Added note "(sim)" to Detail 4/S400.

C. Added note, "Existing bottom edge of concrete beam is badly deteriorated. Refer to detail."

ITEM S2 Drawing S202 – Partial Top Slab Plan (Revised and reissued)

A. Modified note, "S.O.G refer to arch" to "Refer to Detail 2/S301."

ITEM \$3 Drawing \$300 – General Sections and Details (Revised and reissued)

A. Revised Detail 4.

ITEM S4 Drawing S301 – Typical Concrete Details (Revised and reissued)

A. Revised Detail 2.

ELECTRICAL DRAWINGS:

ITEM E1 MED2-01 – Lower Level Mechanical and Electrical Demolition Plan (Revised & Re-Issued)

A. Revised switch and branch circuit location as indicated


B. Revised light fixture and branch circuit for corridor as indicated

ITEM E2 M2-01 Lower Level Mechanical and Electrical Plan (Revised & Re-Issued)

A. Relocated switch and branch circuit as indicated.

B. Re-install light fixture and branch circuit for corridor as indicated.

END OF ADDENDUM

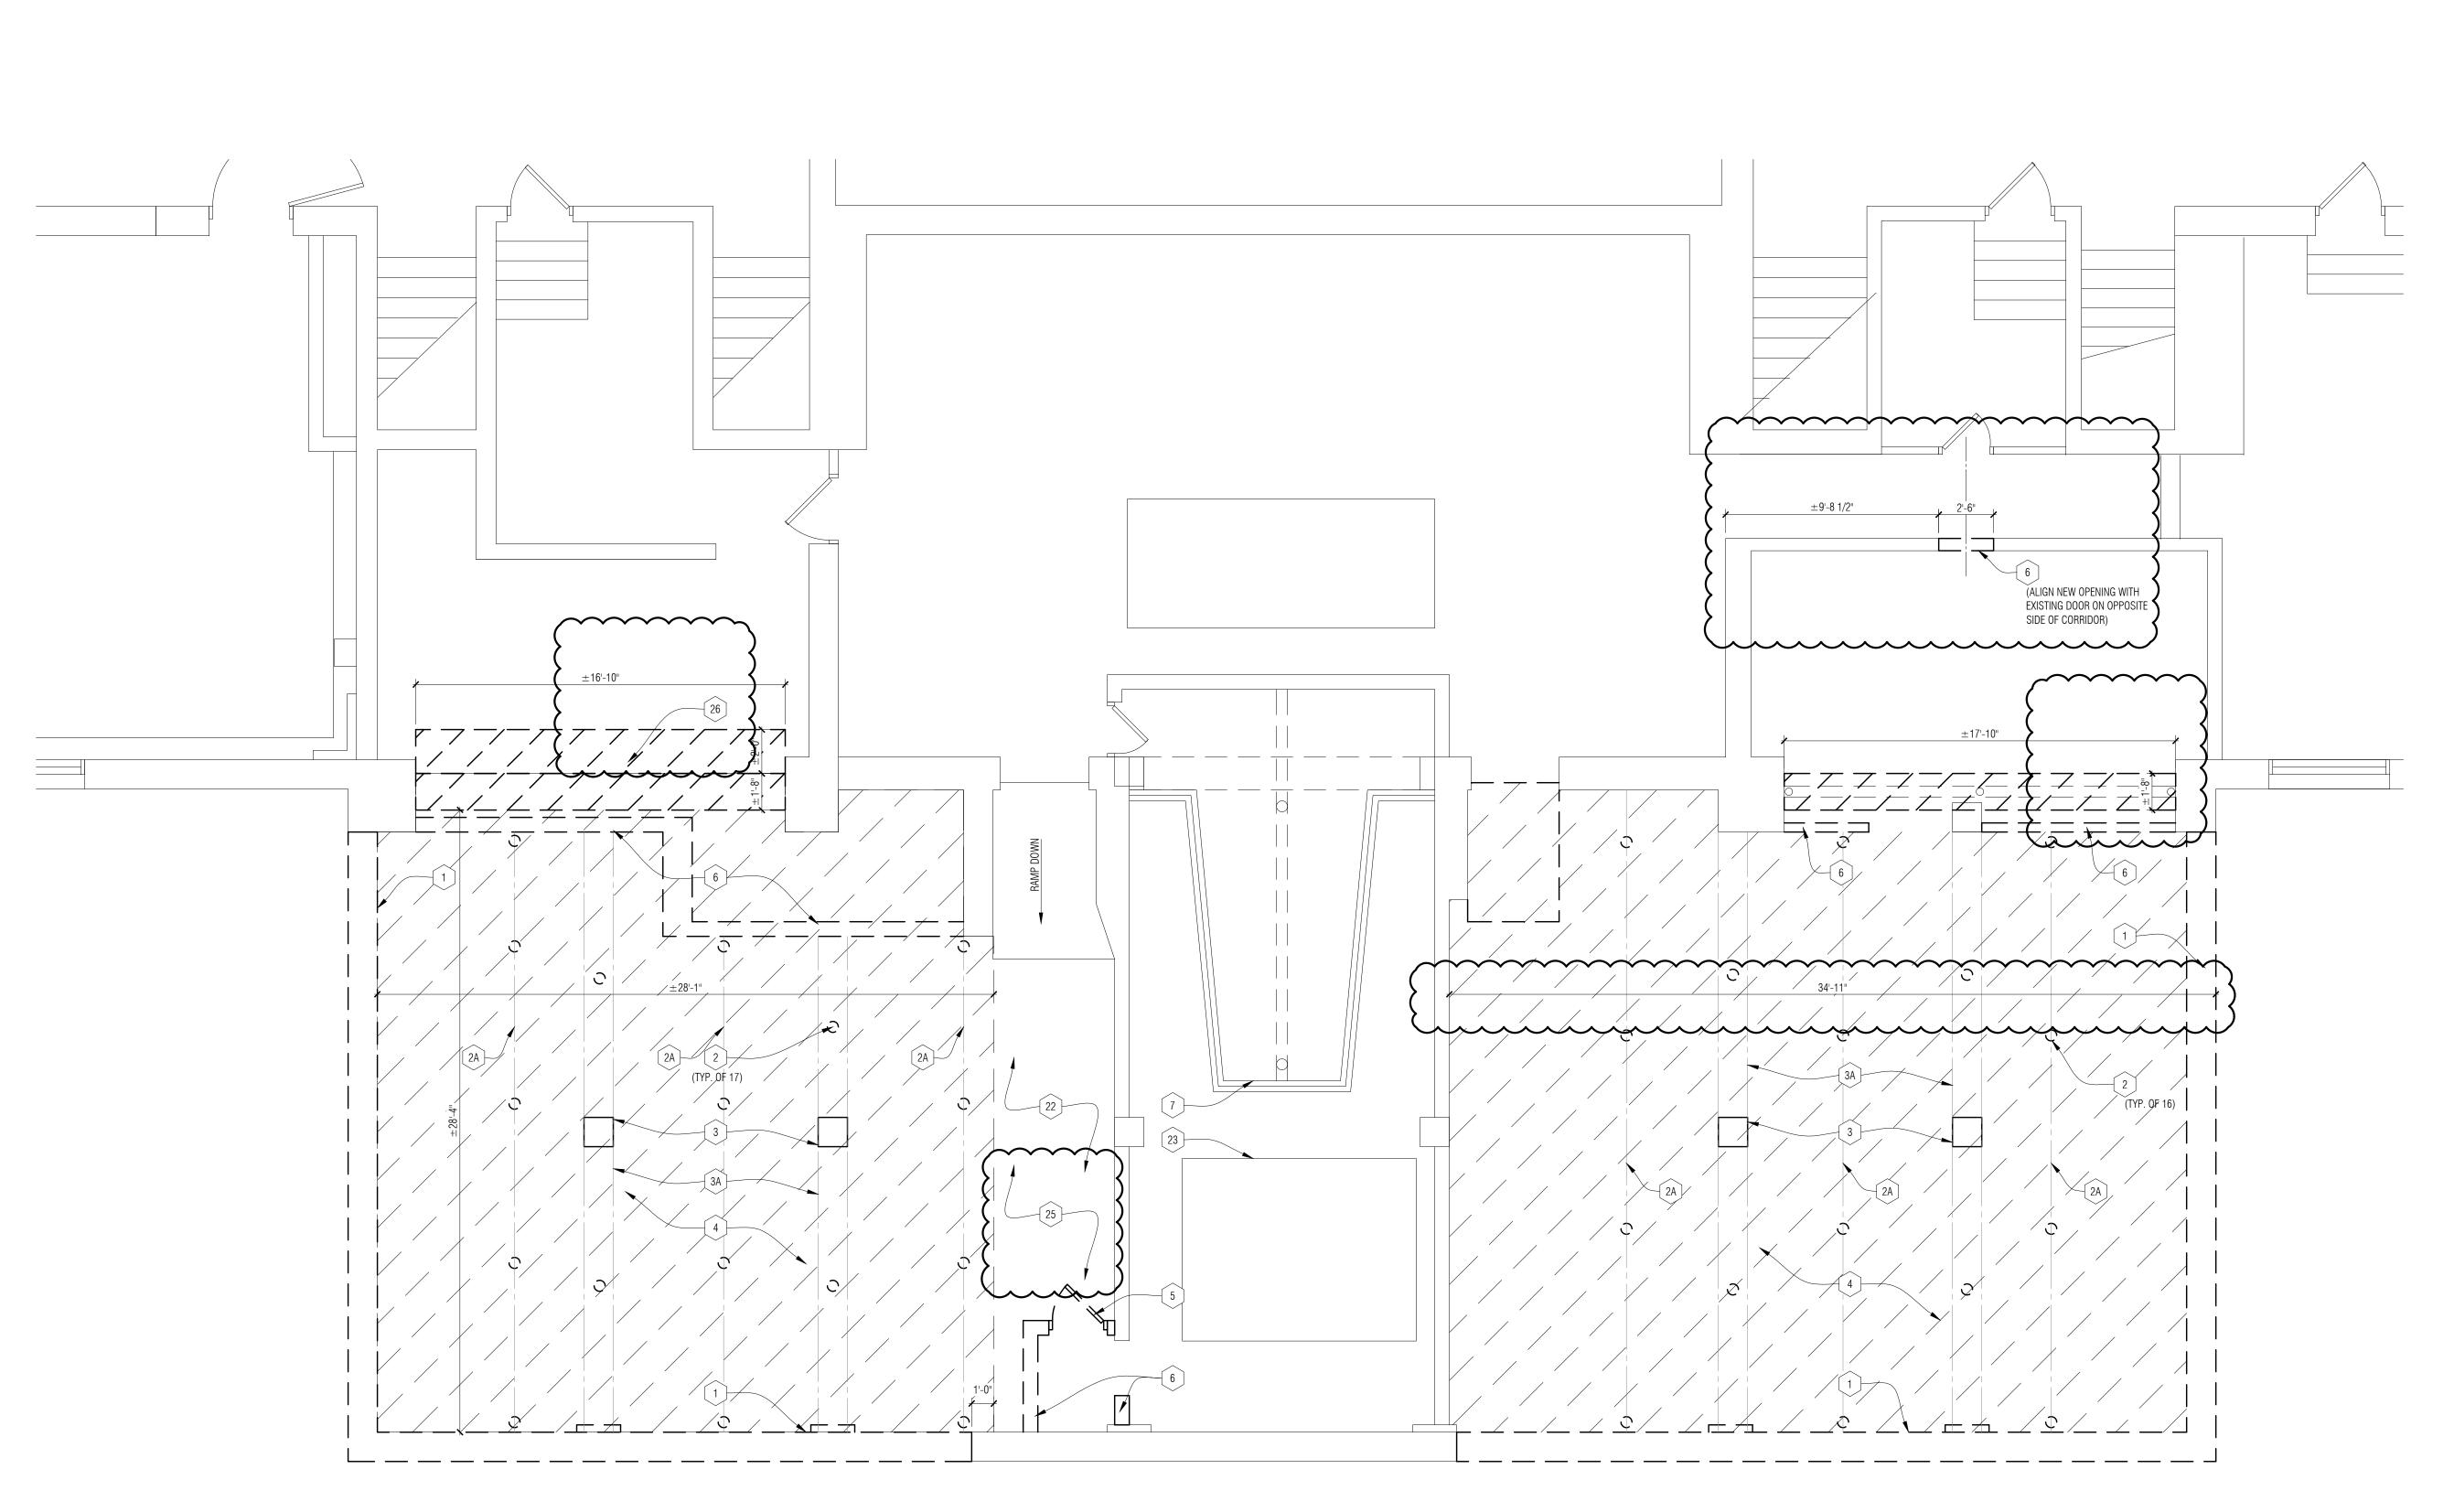




- A. CONTRACTOR IS RESPONSIBLE FOR FIELD VERIFYING AND UNDERSTANDING EXISTING CONDITIONS PRIOR TO STARTING WORK. B. ASBESTOS AND OTHER HAZARDOUS MATERIALS WILL BE REMOVED BY OWNER'S ABATEMENT CONTRACTOR PRIOR TO START OF
- CONSTRUCTION. IF ANY SUSPECTED HAZARDOUS MATERIAL IS ENCOUNTERED, STOP WORK IN THAT AREA, AND IMMEDIATELY INFORM THE CONSTRUCTION MANAGER AND THE ARCHITECT.
- C. DO NOT SCALE DRAWINGS. USE DIMENSIONS PROVIDED AND VERIFY IN FIELD. IF A CONFLICT IS ENCOUNTERED OR A REQUIRED DIMENSION IS NOT PROVIDED, REQUEST A CLARIFICATION FROM THE ARCHITECT.
- D. NOTIFY ARCHITECT OF ANY DISCREPANCIES AND/OR CONFLICTS WITH FLOOR PLANS OR EXISTING CONDITIONS PRIOR TO STARTING WORK.
- E. ALL DEMOLITION MEANS, METHODS AND SAFETY PRECAUTIONS SHALL BE THE SOLE RESPONSIBILITY OF THE CONTRACTOR.
- F. CONTRACTOR SHALL BE RESPONSIBLE FOR PROTECTING EXISTING BUILDING ELEMENTS AND SITE FROM DAMAGE CAUSED BY CONSTRUCTION OR CONSTRUCTION TRADES, AND SHALL REPAIR ANY DAMAGED AREAS AT NO ADDITIONAL COST TO THE OWNER.
- G. DEMOLITION DRAWINGS AND DETAILS ARE PROVIDED TO SHOW THE GENERAL SCOPE OF THE DEMOLITION WORK. IT IS THE CONTRACTORS RESPONSIBILITY TO PERFORM ALL DEMOLITION WORK NECESSARY TO ACCOMPLISH THE NEW WORK. COORDINATE WITH ALL TRADES
- H. DISPOSE OF ALL DEMOLITION MATERIALS LEGALLY OFF SITE.
- I. PREP ALL NEW MASONRY OPENINGS TO RECEIVE NEW TOOTHED-IN MASONRY FOR LIKE NEW APPEARANCE WHERE DEMOLITION OCCURS AND WALL IS VISIBLE. COORDINATE WITH MASON.

DEMOLITION PLAN KEY NOTES:

- EXISTING FOUNDATION WALL TO BE REMOVED. SHORE EXISTING TO REMAIN WALLS AS REQUIRED.
- 2 EXISTING STEEL TUBE COLUMN TO BE REMOVED.
- 2A EXISTING STEEL BEAM TO BE REMOVED.
- 3 EXISTING CONCRETE PIER TO BE REMOVED.
- 3A EXISTING CONCRETE BEAM TO BE REMOVED. 4 SAW CUT AND REMOVE EXISTING FLOOR SLAB (POCHE'D AREA)
- [5] EXISTING DOOR AND FRAME TO BE REMOVED.
- 6 EXISTING CMU WALL CONSTRUCTION TO BE REMOVED COORDINATE LOCATION SO HEIGHT OF NEW DOOR DOES NOT DISTURB EXISTING WALL MOUNTED PIPES.
- 7 AIR FILTER ENCLOSURE TO REMAIN. PROTECT DURING DEMOLITION & CONSTRUCTION
- 8 ASPHALT PAVING TO BE REMOVED.
- 9 EXISTING CONCRETE DECK BELOW ASPHALT PAVING TO BE REMOVED.
- 10 EXISTING CONCRETE DECK BELOW ASPHALT PAVING TO REMAIN.
- 11 EXISTING CONCRETE WALK TO BE REMOVED TO NEAREST JOINT.
- [12] EXISTING FLAG POLE TO REMAIN.
- 13 EXISTING CONCRETE STEPS AND END CAPS TO BE REMOVED.
- EXISTING GAS METERING EQUIPMENT TO REMAIN PROTECT DURING DEMOLITION AND CONSTRUCTION - REFER TO MECHANICAL FOR GAS LINE REWORK.
- 15 EXISTING LOUVER TO BE REMOVED.
- REMOVE EXISTING MASONRY TO EXTEND EXISTING LOUVER OPENING WIDTH. SHORE EXISTING WALL AS REQUIRED FOR LINTEL INSTALLATION. COORDINATE WITH MECH FOR FINAL OPENING SIZE REQUIRED.
- EXISTING CONCRETE WALL & METAL ROOF ENCLOSURE TO BE REMOVED.
- EXISTING FACE BRICK TO BE REMOVED. REMOVE MIN. OF 8"
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- EXISTING LIMESTONE END CAPS TO BE REMOVED AND SALVAGED FOR REUSE. CONTRACTOR TO MARK CAPS TO ALLOW REINSTALLATION AT SAME LOCATION.
- REMOVE BRICK IN SAW TOOTH FASHION TO ALLOW FOR INSTALLATION OF NEW BRICK.

AND CONSTRUCTION.

- EXISTING LIMESTONE STEP TO REMAIN PROTECT DURING DEMOLITION AND CONSTRUCTION.
- EXISTING CONC TO REMAIN PROTECT DURING DEMOLITION AND CONSTRUCTION.
- 23 EXISTING MECHANICAL TO REMAIN PROTECT DURING DEMOLITION
- EXISTING CONC TO BE REMOVED AS REQUIRED TO COMPLETE NEW SITE WORK.
- REMOVE ANY CHIPPED, CRACKED OR FRAGMENTED AREAS OF EXISTING CONCRETE DECK SURFACES ABOVE FUTURE CORRIDOR.
- REMOVE PORTION OF CRACKED PLASTER CEILING AND PREP AREA TO RECEIVE NEW PAINT.

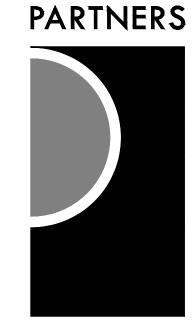

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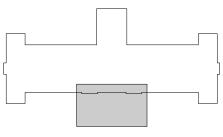
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SPECIFICALLY FOR "BIDDING / CONSTRUCTION"

CONSULTANT



Public Schools

PROJECT NAME

Kosciuszko Middle School Structural Repairs

2333 Burger St. Hamtramck, MI 48212

PROJECT NO.

21-167

ISSUES / REVISIONS

Bidding / Construction 11/17/2022 Addendum No. 1


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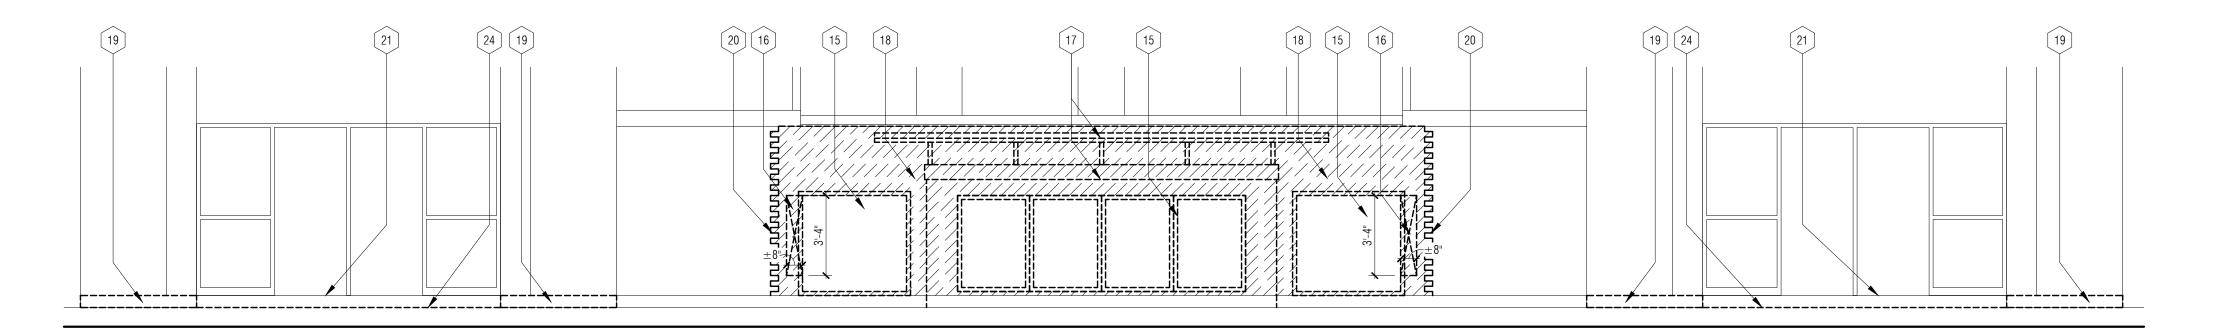
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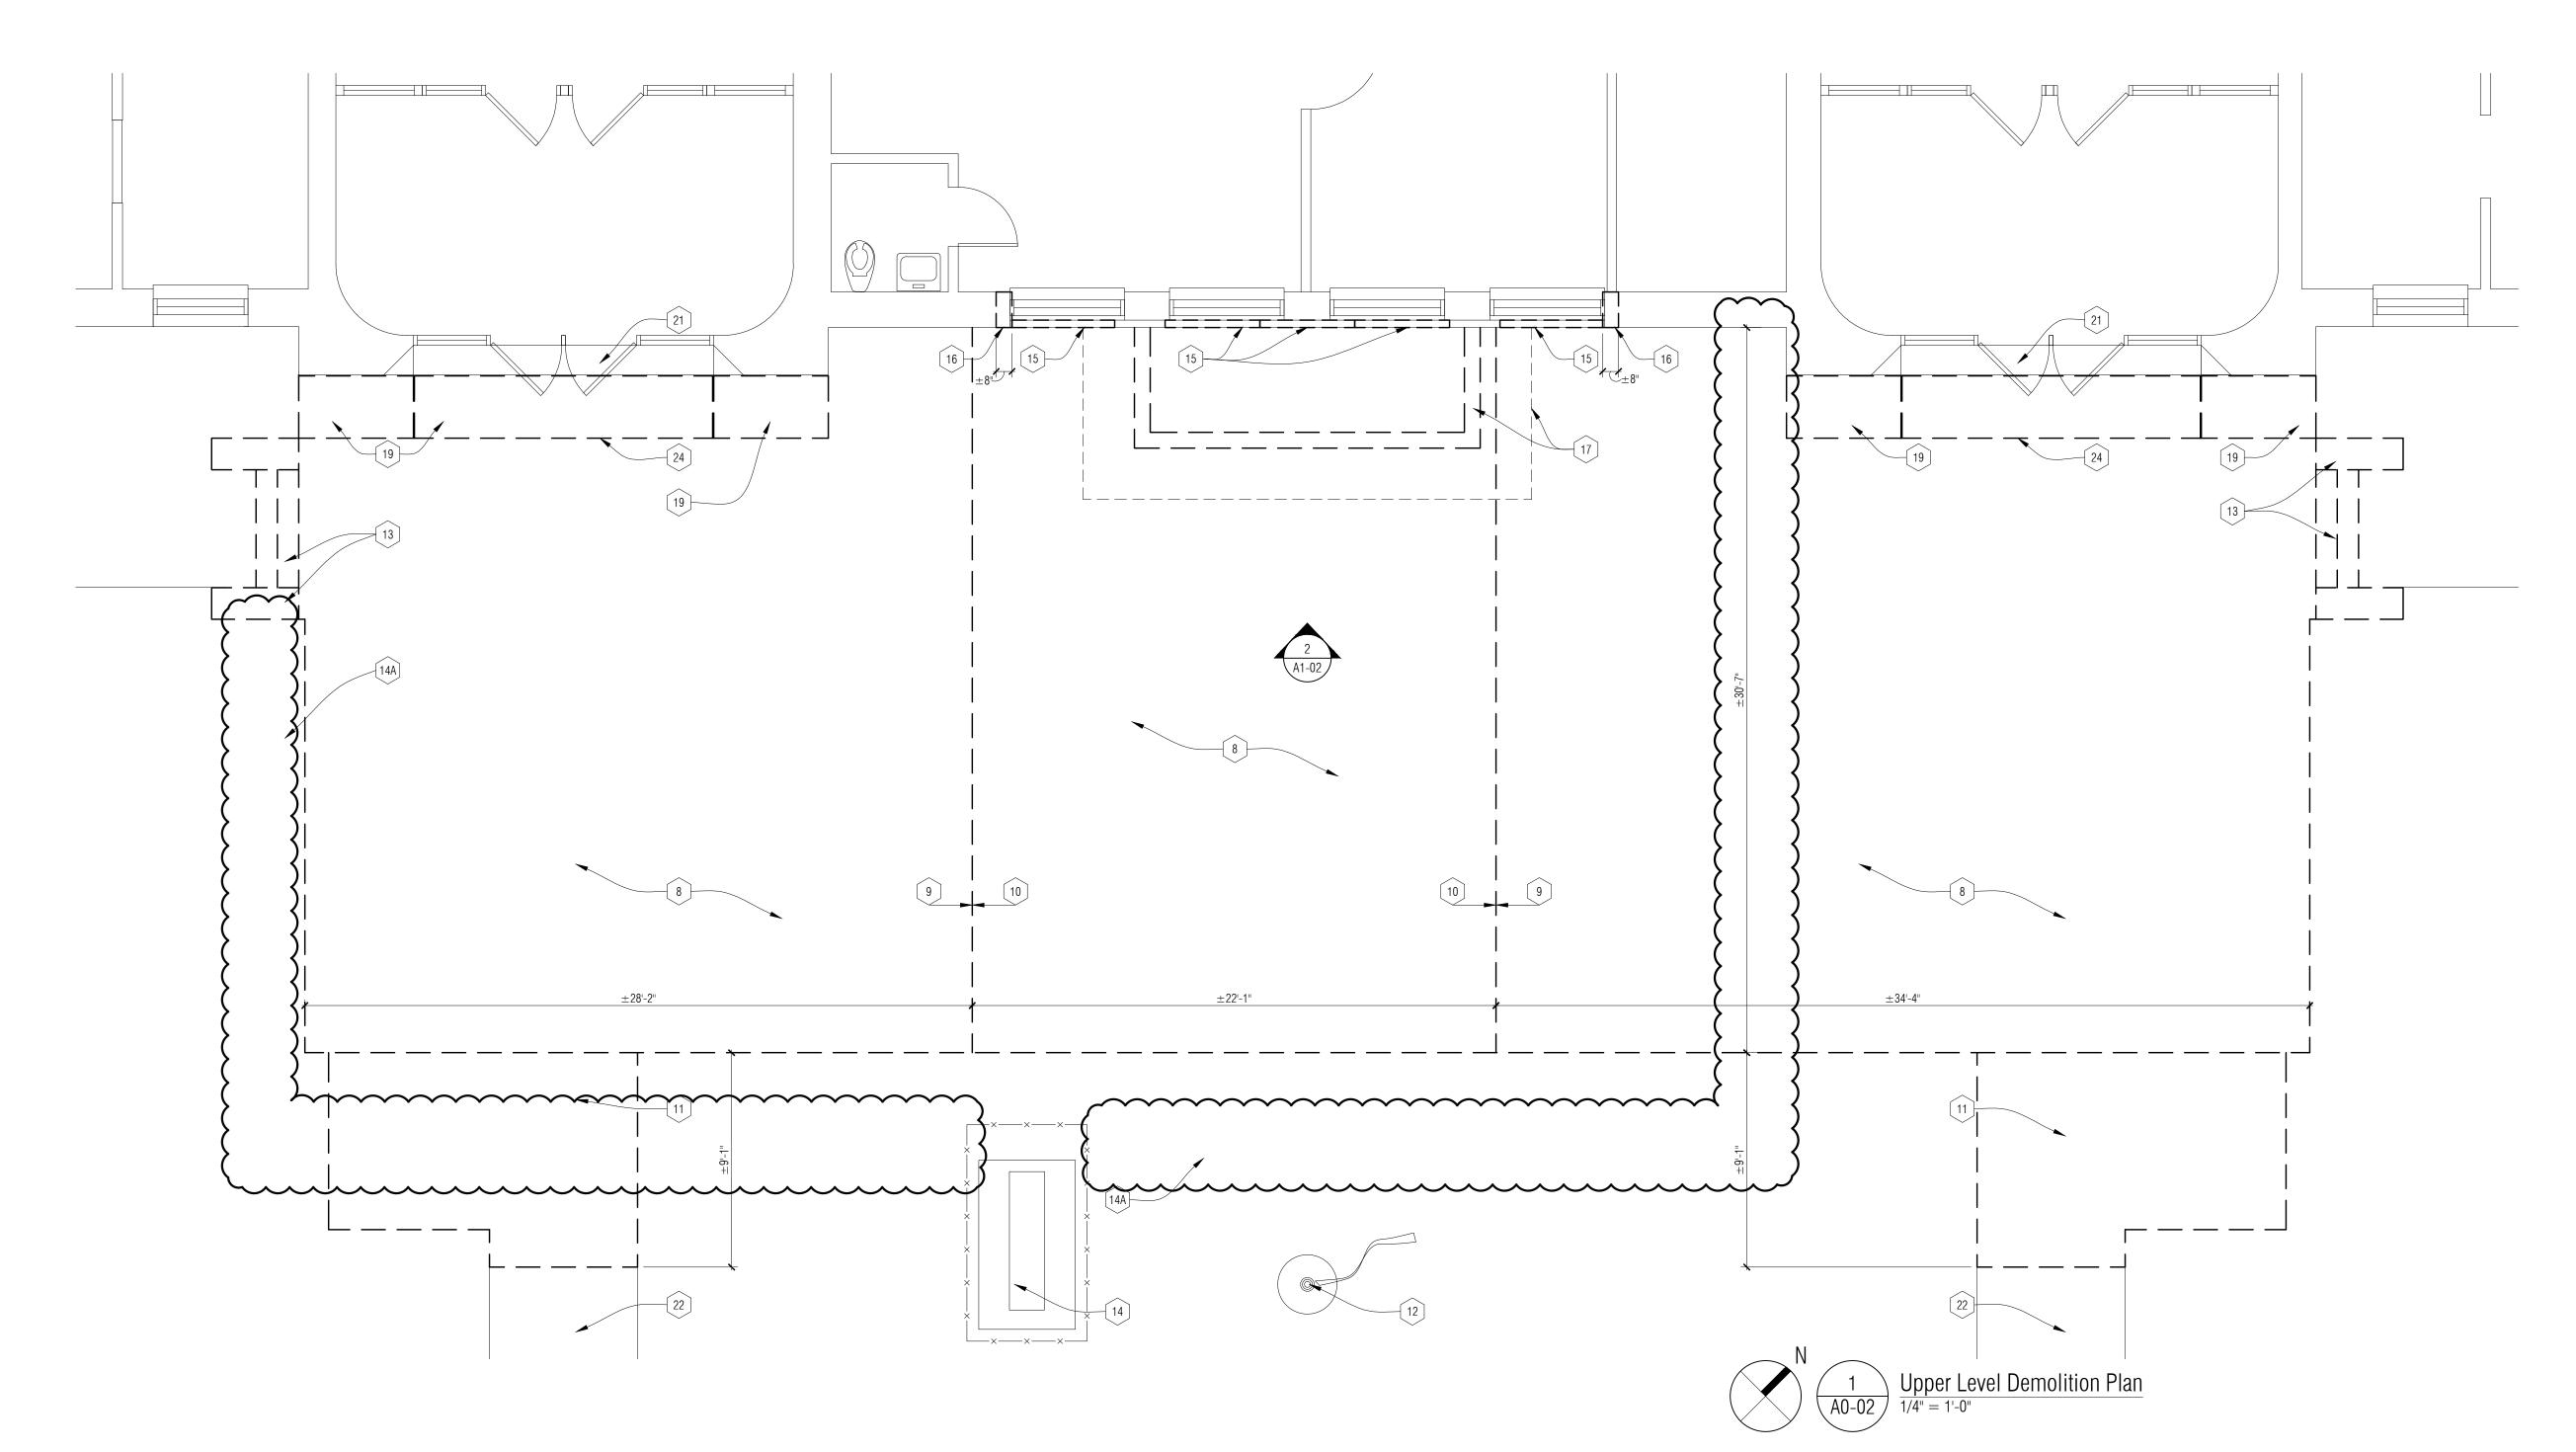
LOWER LEVEL DEMOLITION PLAN

A1-01







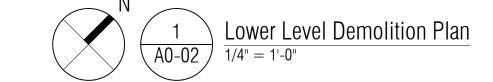

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UNDERSTANDING EXISTING CONDITIONS PRIOR TO STARTING WORK.

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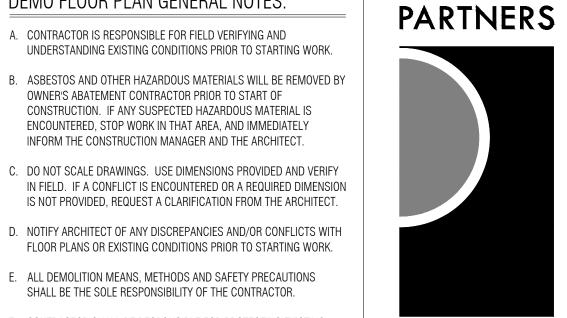
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H. DISPOSE OF ALL DEMOLITION MATERIALS LEGALLY OFF SITE.

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CONSTRUCTION OR CONSTRUCTION TRADES, AND SHALL REPAIR ANY

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CONSULTANT

KEY PLAN

Hamtramck

PROJECT NAME

School

2333 Burger St. Hamtramck, MI 48212

PROJECT NO.

21-167

ISSUES / REVISIONS

Addendum No. 1

Bidding / Construction 11/17/2022

Public Schools

Kosciuszko Middle

Structural Repairs

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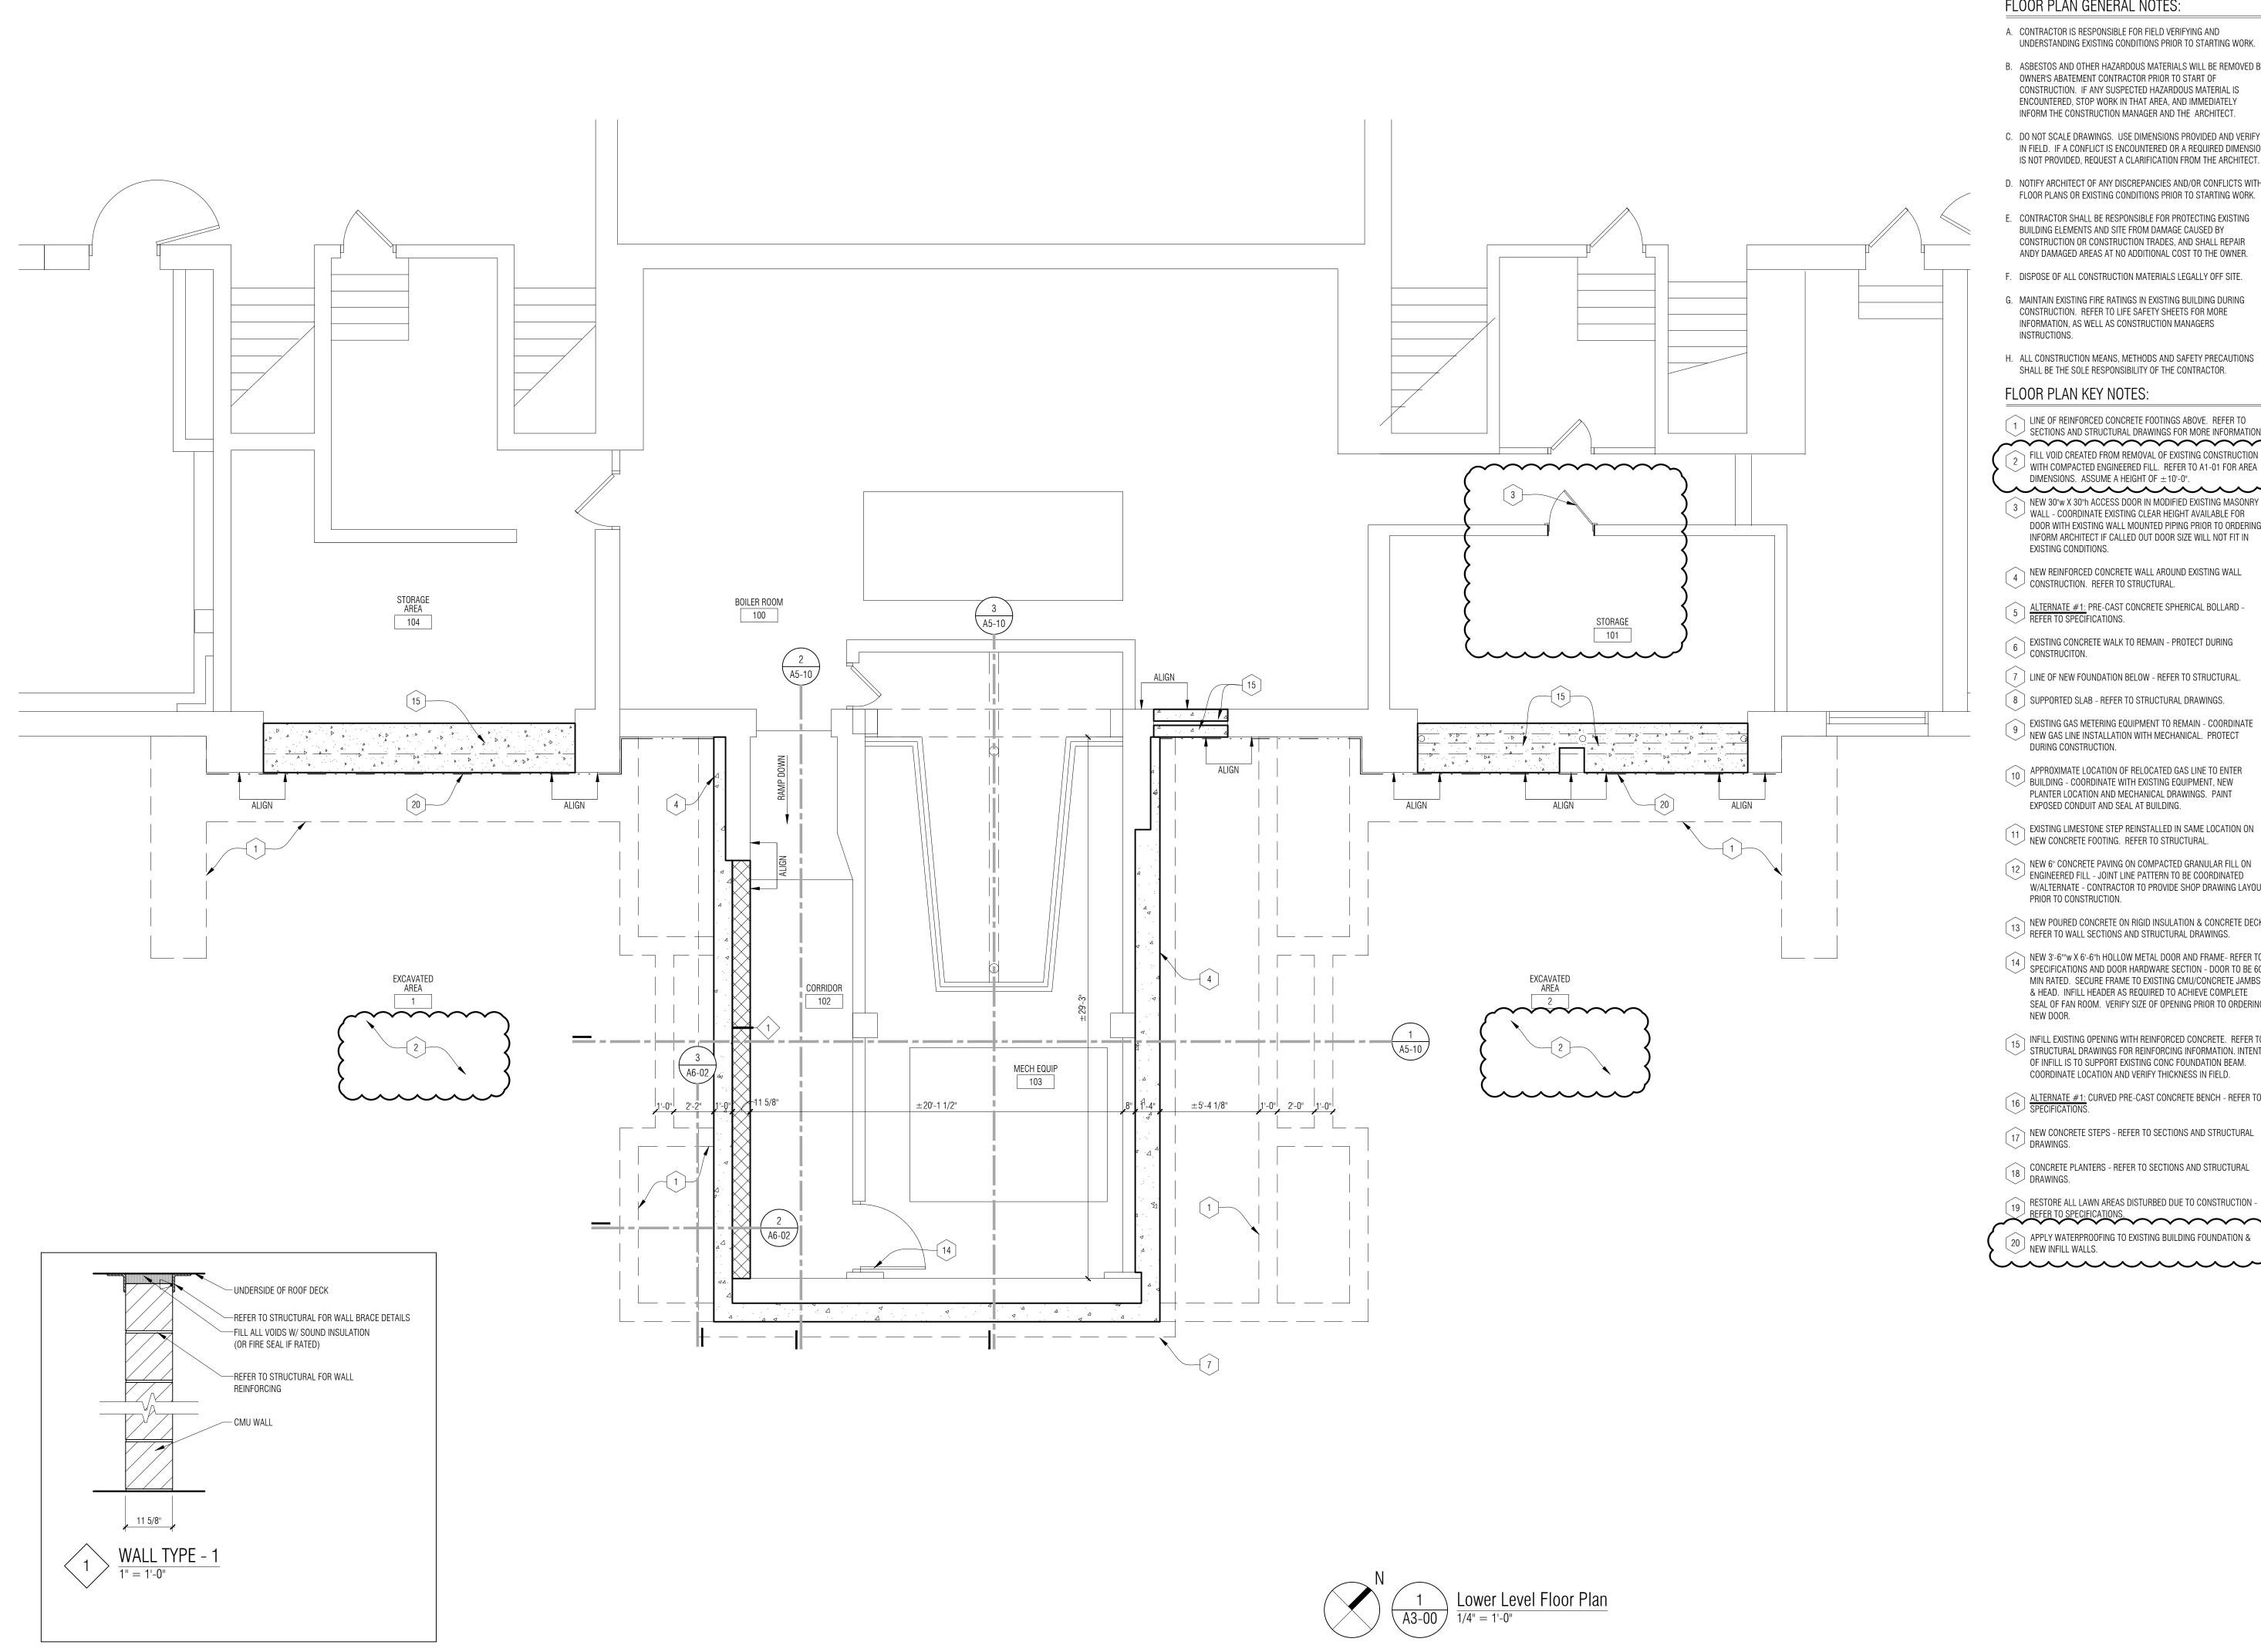
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UPPER LEVEL DEMOLITION PLAN & ELEVATION

A1-02

P:\2021\21-167-HPS KMS Basement Ceiling Emergency Repair\02_CAD\A1-02 Demo Floor Plan.dwg - 12/5/2022 10:19:31 AM - Chris Prieb




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- NEW 6" CONCRETE PAVING ON COMPACTED GRANULAR FILL ON ENGINEERED FILL - JOINT LINE PATTERN TO BE COORDINATED W/ALTERNATE - CONTRACTOR TO PROVIDE SHOP DRAWING LAYOUT PRIOR TO CONSTRUCTION.
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- 15 INFILL EXISTING OPENING WITH REINFORCED CONCRETE. REFER TO STRUCTURAL DRAWINGS FOR REINFORCING INFORMATION. INTENT OF INFILL IS TO SUPPORT EXISTING CONC FOUNDATION BEAM. COORDINATE LOCATION AND VERIFY THICKNESS IN FIELD.
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- 20 APPLY WATERPROOFING TO EXISTING BUILDING FOUNDATION & NEW INFILL WALLS.

PARTNERS



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MOUNT CLEMENS, MI 48043 P 586.469.3600

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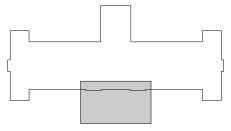
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CONSULTANT

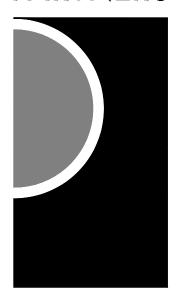KEY PLAN



Public Schools

PROJECT NAME

Kosciuszko Middle School Structural Repairs

2333 Burger St. Hamtramck, MI 48212

PROJECT NO.

21-167

ISSUES / REVISIONS

Bidding / Construction 11/17/2022 Addendum No. 1 12/06/2022

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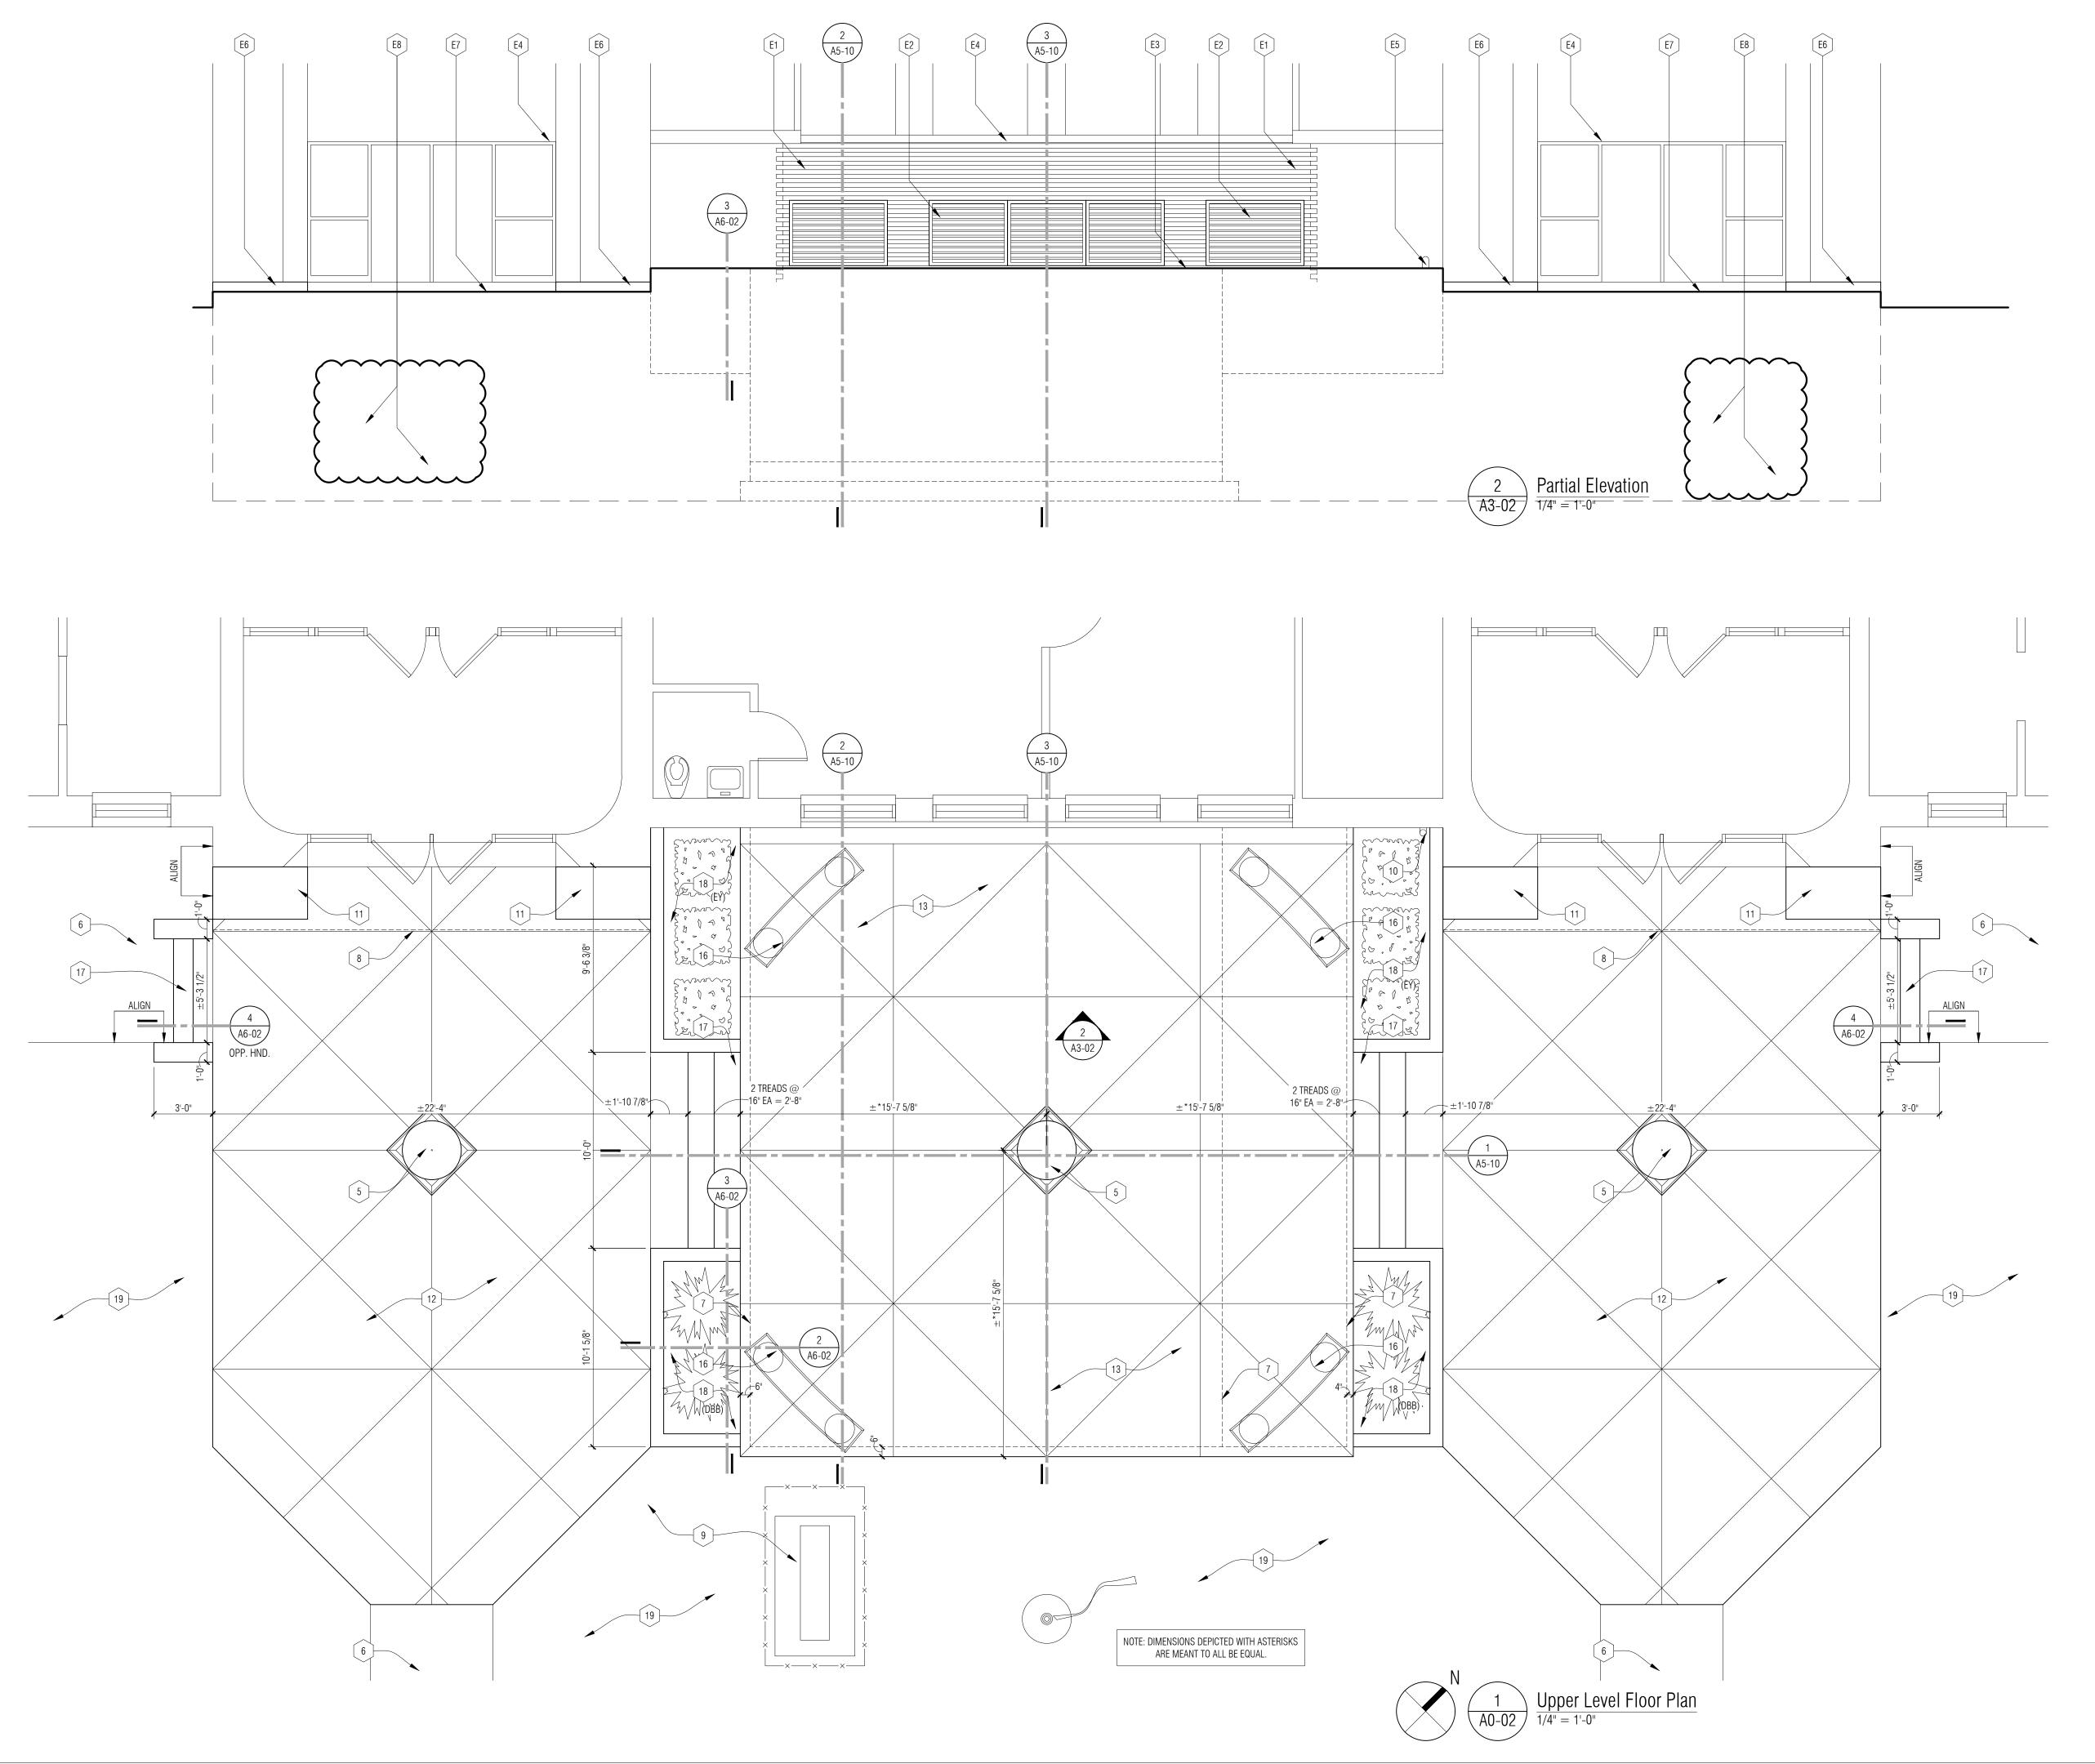
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LOWER LEVEL FLOOR PLAN

A3-01

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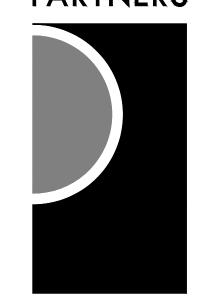
ELEVATION KEY NOTES:

- NEW RUNNING BOND FACE BRICK TO MATCH EXISTING REFER TO SPECIFICATIONS. TOOTH NEW BRICK INTO EXISTING.
- E2 PRE-FINISHED MECHANICAL LOUVER REFER TO MECH.
- [E3] LINE OF NEW CONCRETE DECK.
- E4 EXISTING BUILDING ELEMENTS TO REMAIN.
- E5 RELOCATED GAS LINE REFER TO MECHANICAL DRAWINGS.
- EASISTING LIMESTONE STEP REINSTALLED IN SAME LOCATION ON NEW CONCRETE FOOTING REFER TO STRUCT.
- E7 LINE OF NEW CONCRETE PAVING.
- AREA WHERE EXISTING BASEMENT CONSTRUCTION WAS REMOVED TO BE BACKFILLED WITH COMPACTED ENGINEERED FILL. REFER TO FLOOR PLAN KEYNOTE 2 FOR MORE INFORMATION.

PLANTING SCHEDULE

QTY.	DESCRIPTION	SIZE / ROOT
6	(EY) EVERLOW YEW	30"-36"
4	(DBB)DWARF BURNING BUSH	30"-36"





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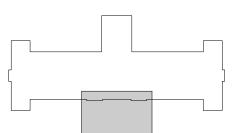
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CONSULTANT

KEY PLAN



Public Schools

PROJECT NAME

Kosciuszko Middle School Structural Repairs

2333 Burger St. Hamtramck, MI 48212

PROJECT NO.

21-167

ISSUES / REVISIONS

Bidding / Construction 11/17/2022 Addendum No. 1 12/06/2022


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SHEET NAME UPPER LEVEL FLOOR PLAN & **ELEVATION**

A3-02



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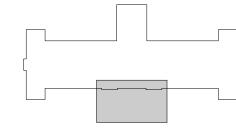
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Addendum No. 1 12/06/2022

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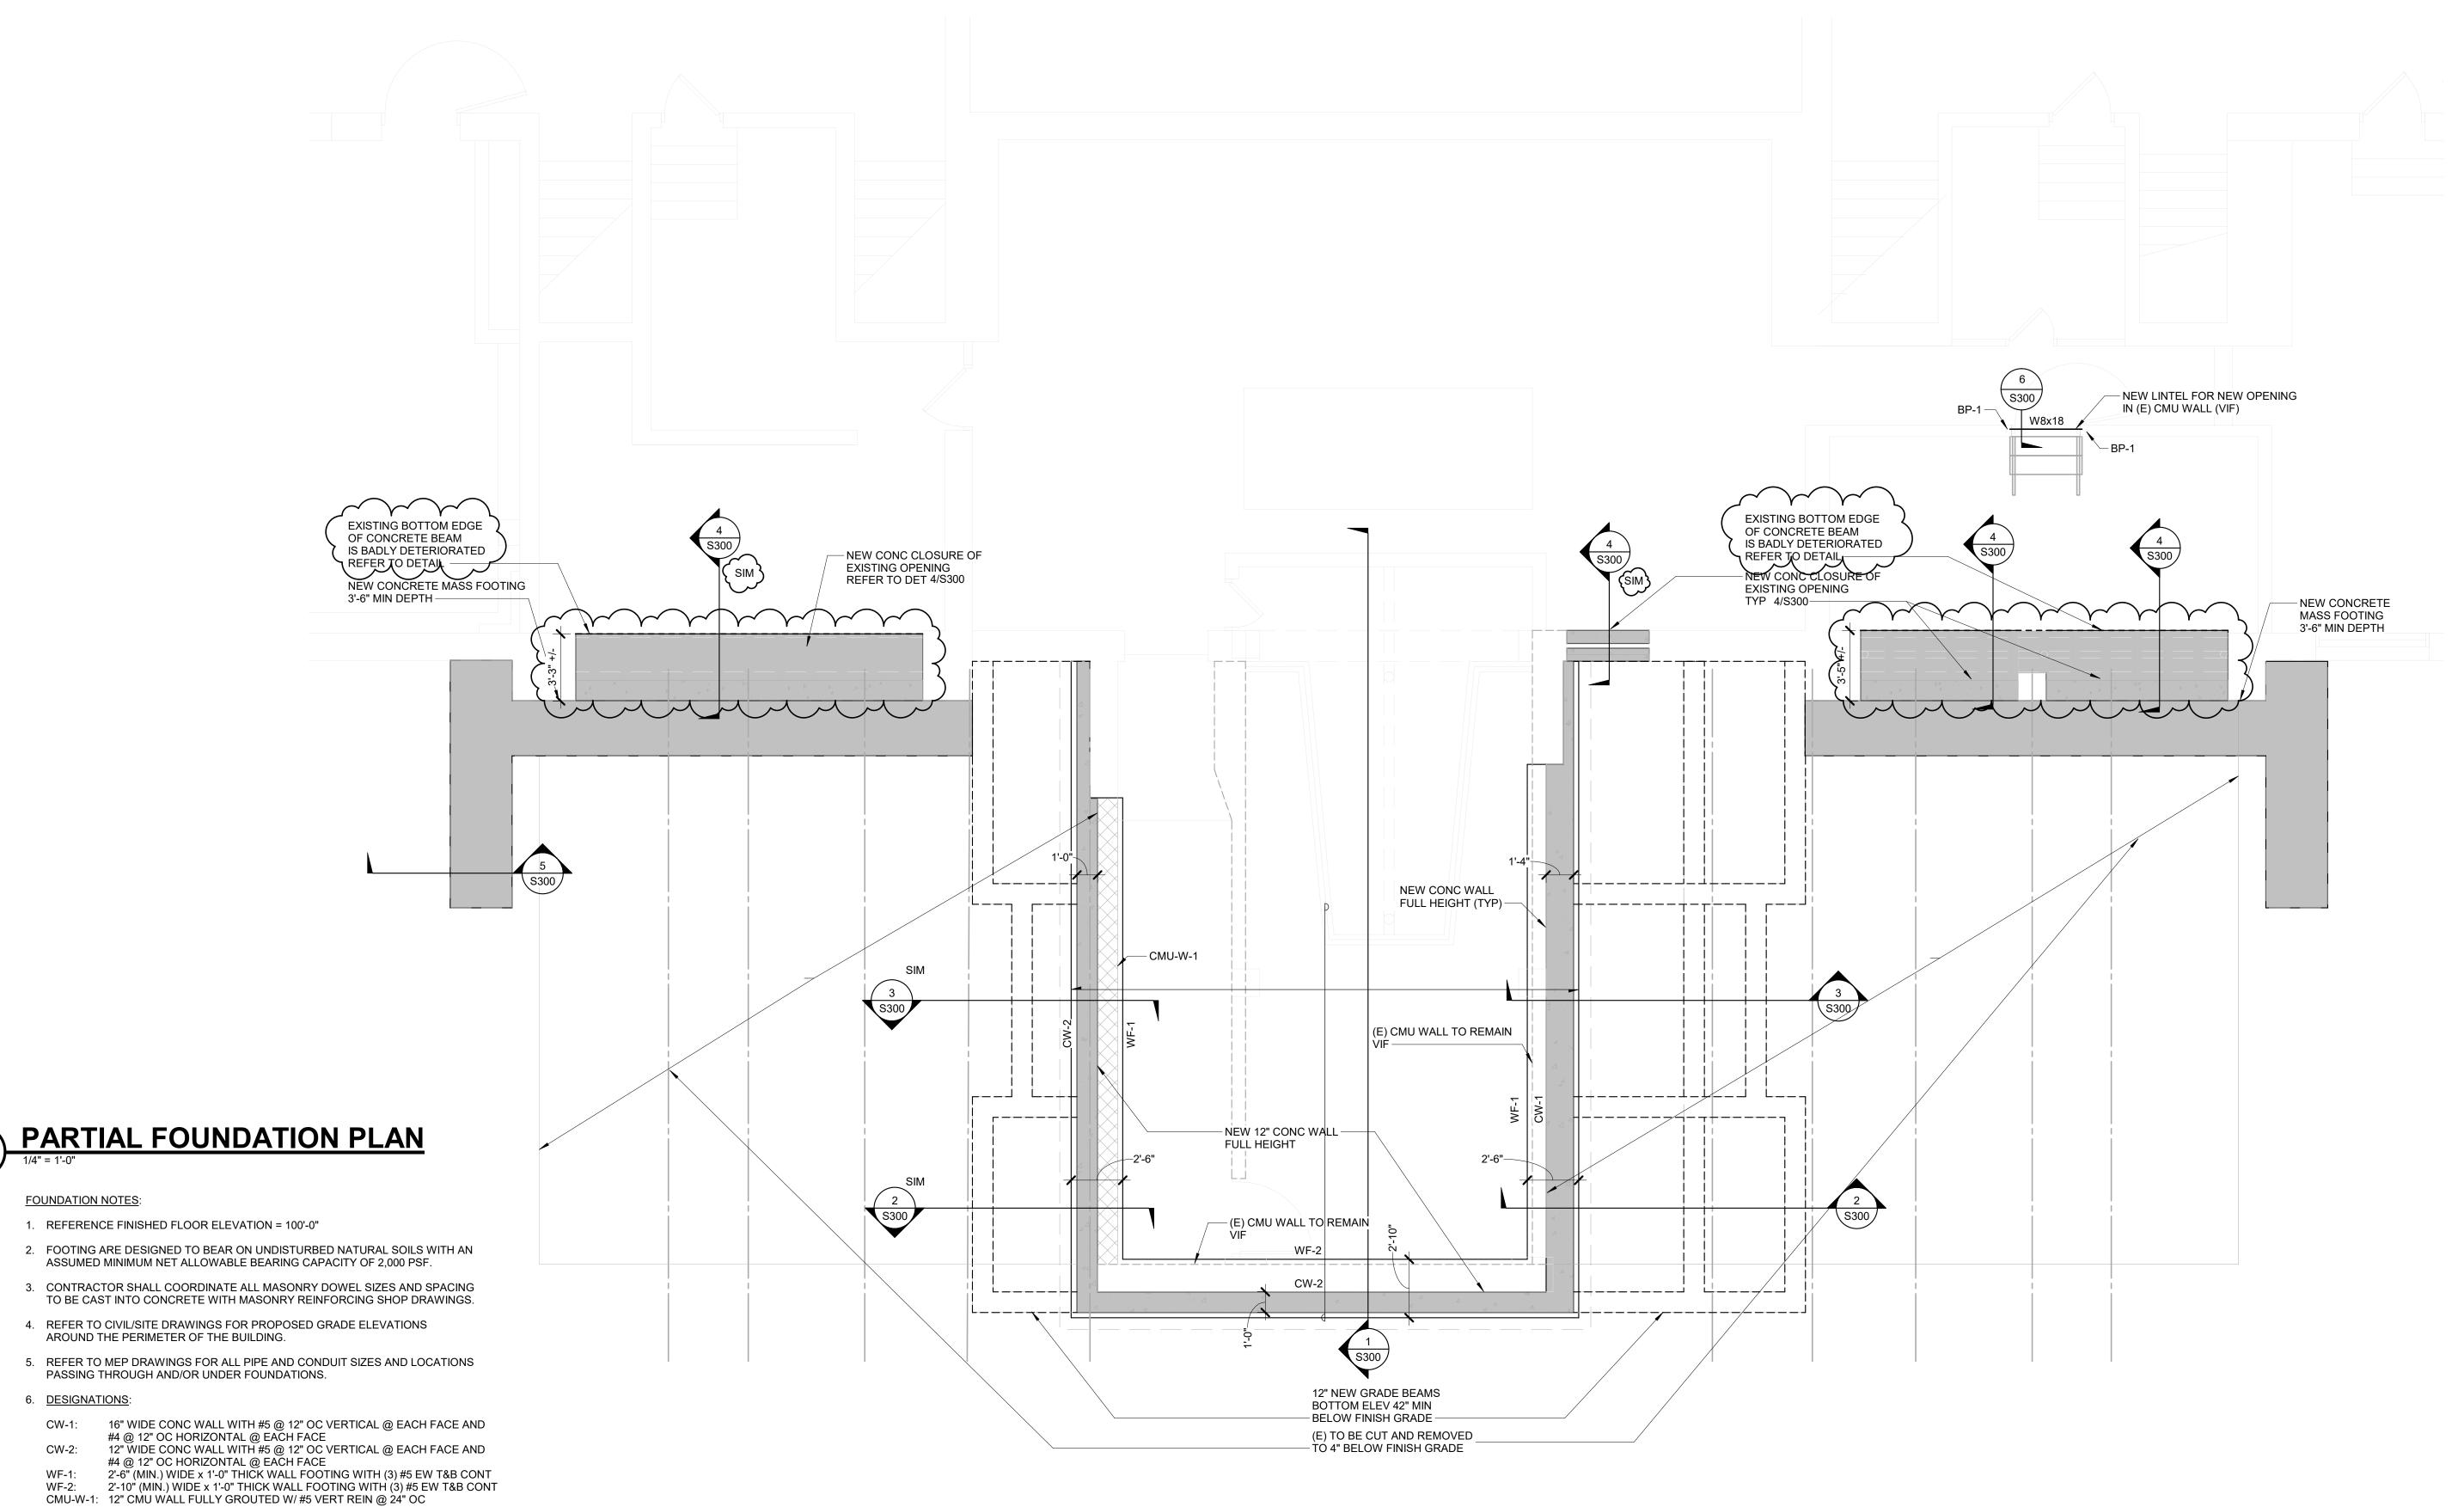
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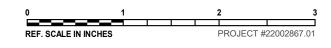
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WALL SECTIONS

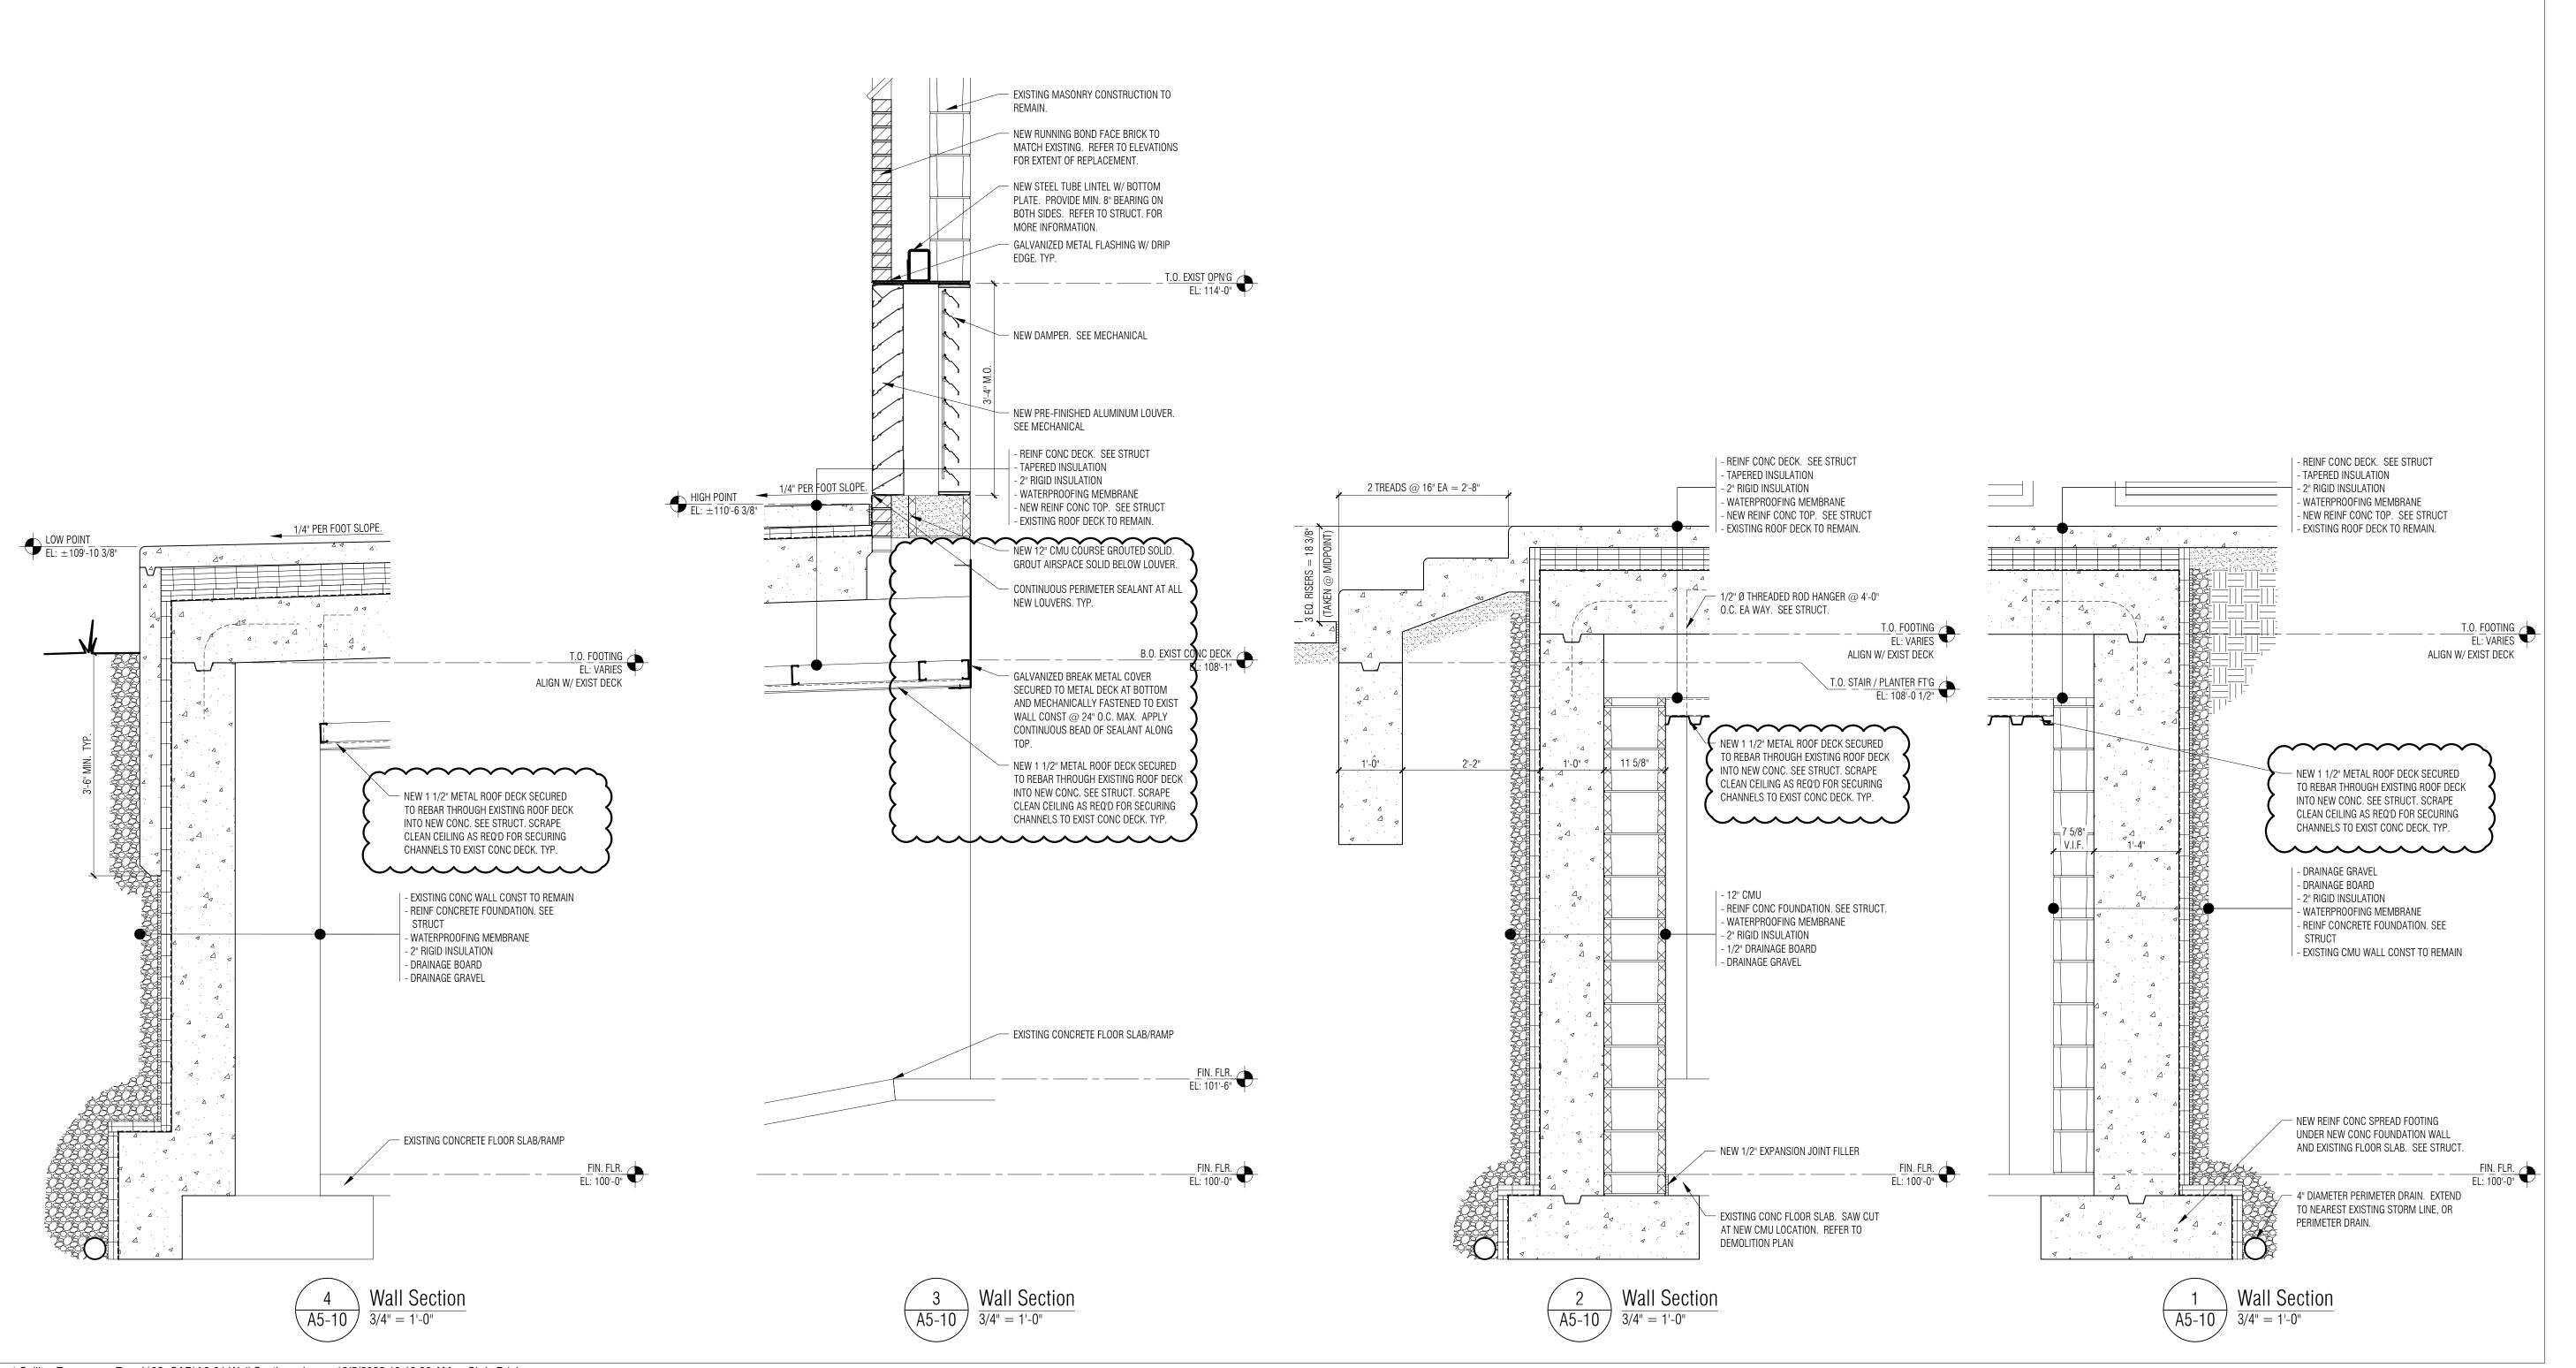
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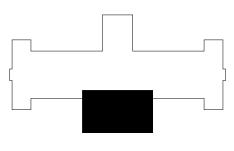
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KEY PLAN



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Hamtramck Public Schools

PROJECT NAME

HPS-Hamtramck-MI-Kosciuszko MS

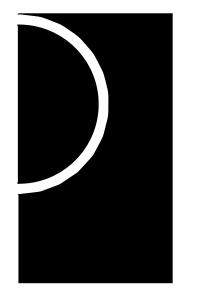2333 Burger St. Hamtramck, MI 48212

PROJECT NO.

22002867.01

ISSUES / REVISIONS

 Bidding / Construction
 11/17/2022

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PARTIAL FOUNDATION PLAN

SHEET NO.

GENERAL STRUCTURAL NOTES


SPECIAL INSPECTION SCHEDULES GENERAL SECTIONS AND DETAILS

TYPICAL CONCRETE DETAILS

7. <u>REFERENCE DRAWINGS</u>:

S001, S002

S300

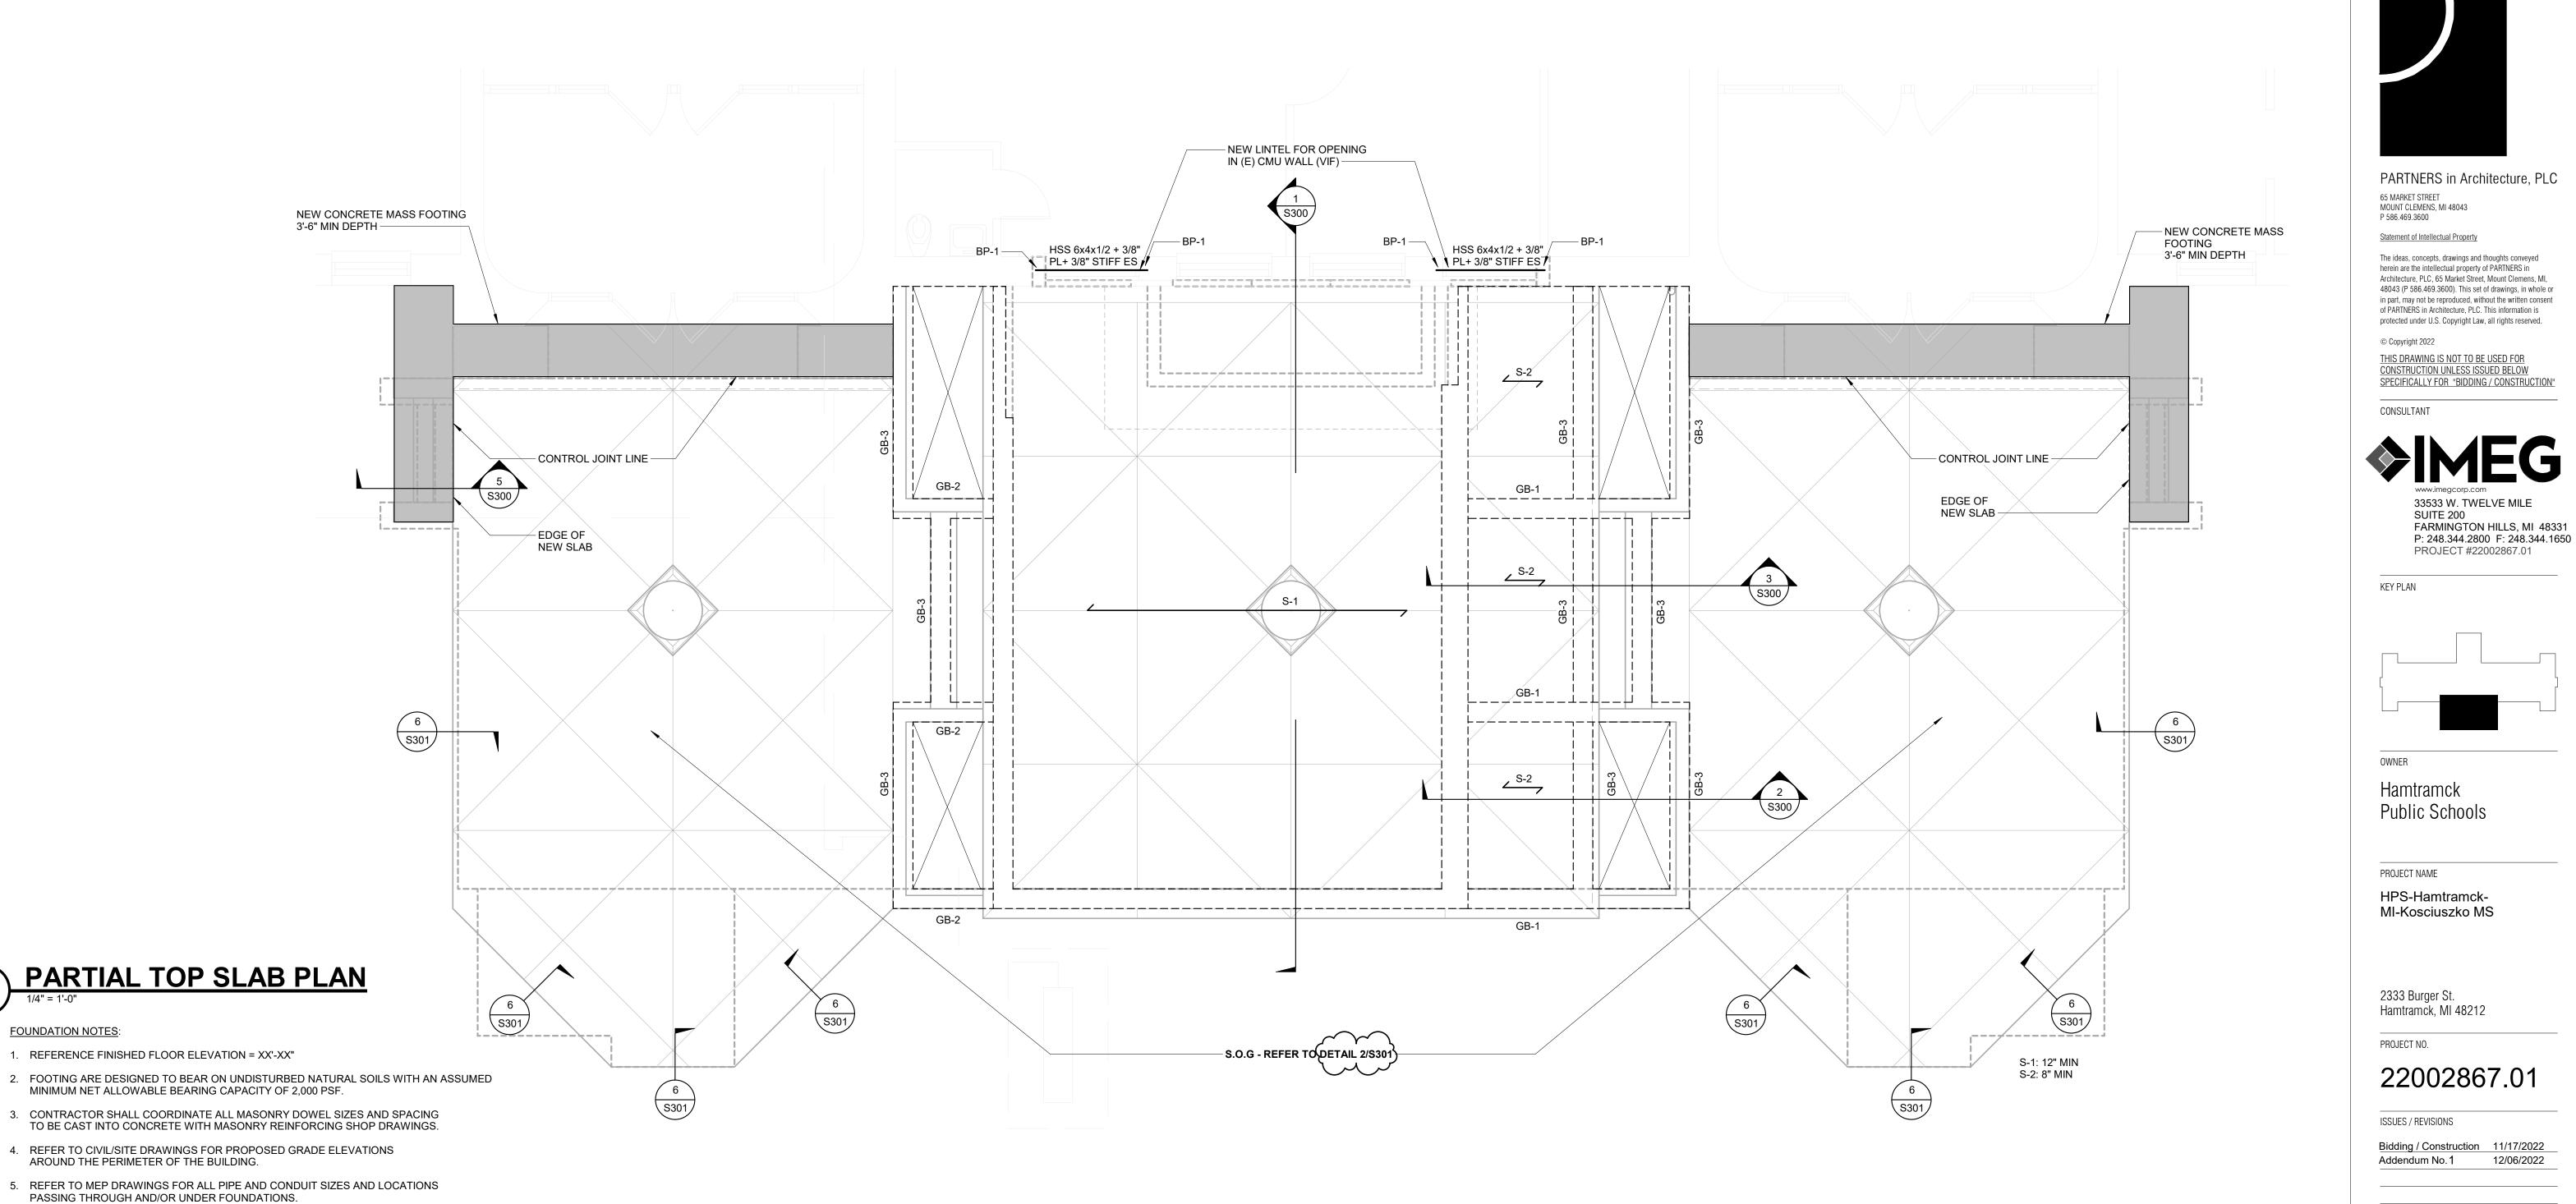

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SLAB PLAN

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REF. SCALE IN INCHES PROJECT #22002867.01

S-1 12" THICK WITH #6 @ 12" OC BOTTOM AND #4 @ 12" OC TOP AND #7 @12" OC TOP & BOTT DOWEL TO EACH END

S-2 8" THICK WITH #4 @ 12" EACH WAY BOTTOM AND 6X6- W2.1 XW2.1 WWF

BP-1 8"x8"x1/2" BEARING PLATE W/ (2) 3/4" HEADED STUDS INTO FULLY GROUTED (E) CMU

GB-1 (3) #6 TOP AND (3) #5 BOTTOM REIN - DOWEL TO CONCRETE WALL

GB-2 (2) #6 TOP AND (2) #5 BOTTOM REIN - DOWEL TO CONCRETE WALL

GENERAL STRUCTURAL NOTES

SPECIAL INSPECTION SCHEDULES

TYPICAL CONCRETE DETAILS

GENERAL SECTIONS AND DETAILS

6. <u>DESIGNATIONS</u>:


GB-3 (2) #5 TOP AND BOTTOM

7. <u>REFERENCE DRAWINGS</u>:

S001, S002


S300

S301

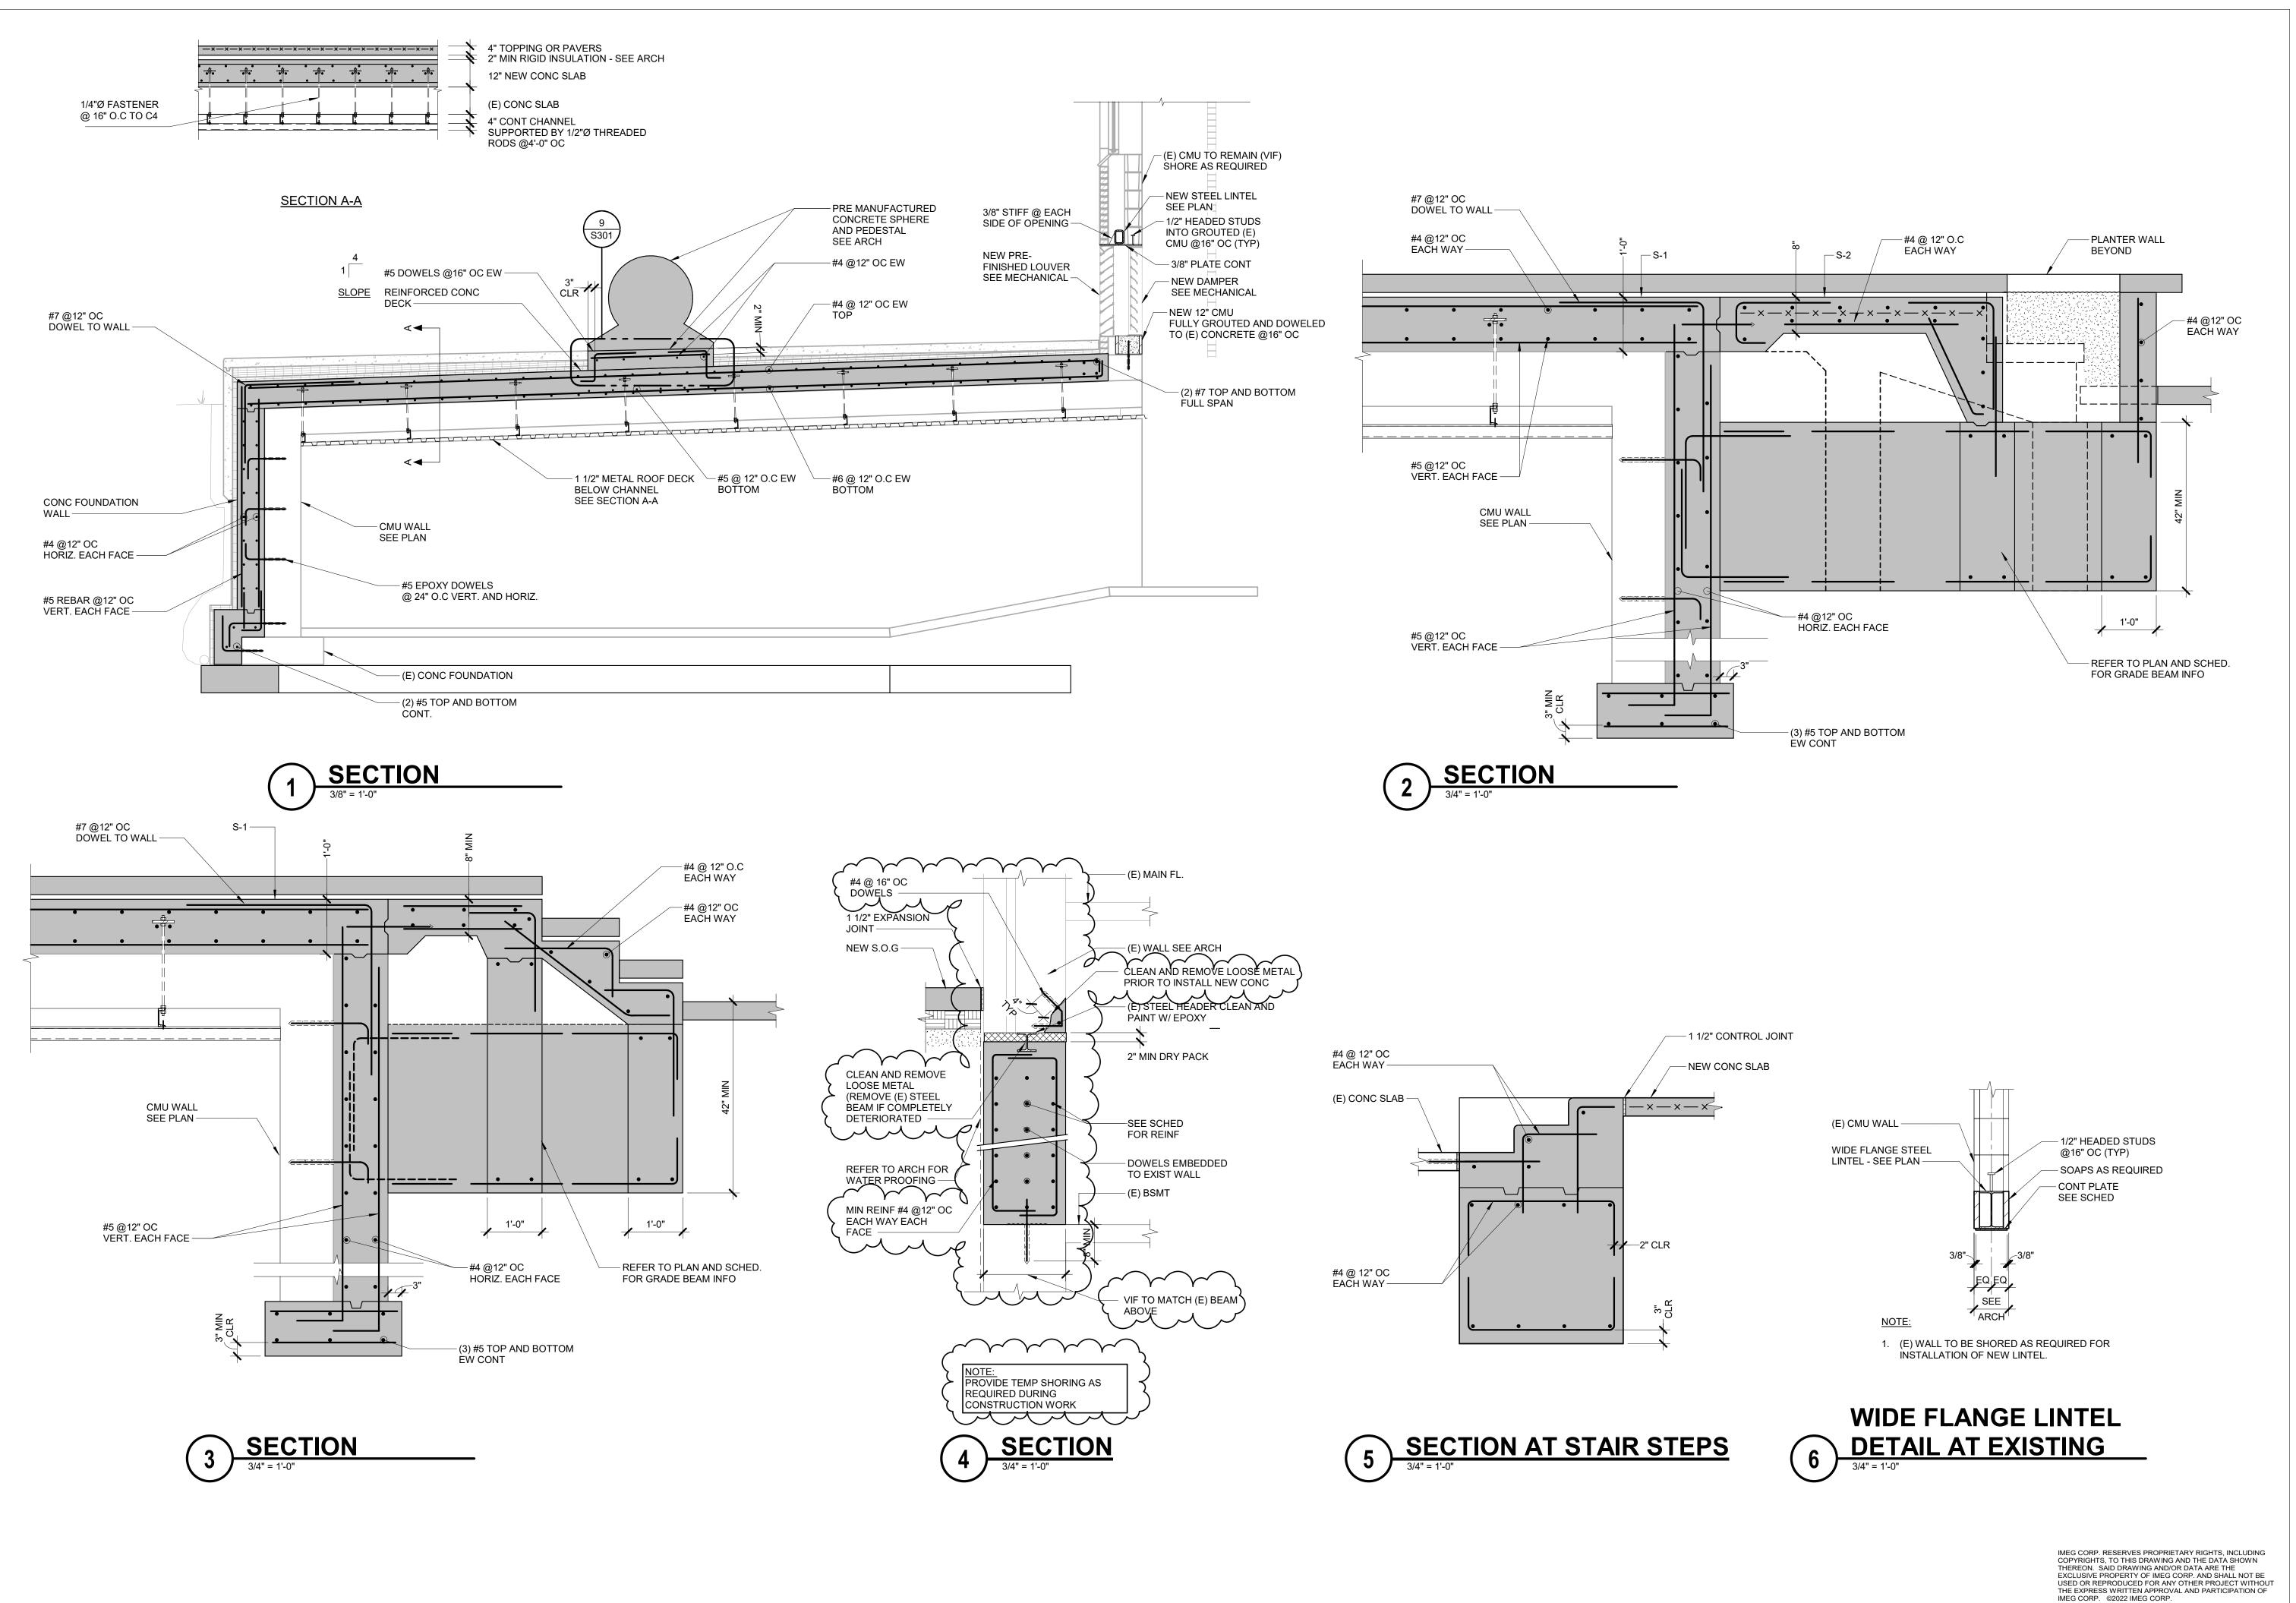

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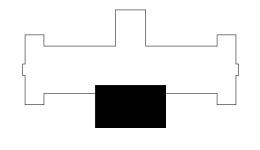
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KEY PLAN

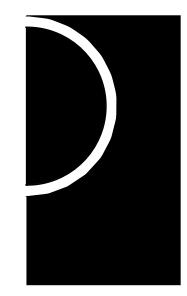

OWNER

Hamtramck Public Schools

PROJECT NAME

HPS-Hamtramck-MI-Kosciuszko MS

2333 Burger St. Hamtramck, MI 48212

PROJECT NO.

22002867.01

Bidding / Construction	11/17/202
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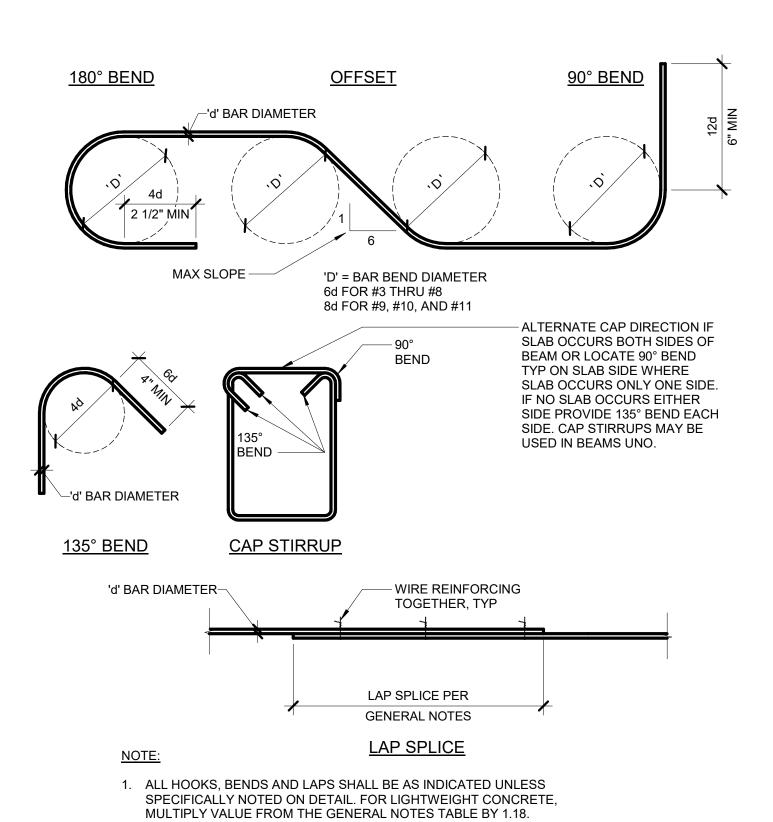
GENERAL SECTIONS AND

DETAILS


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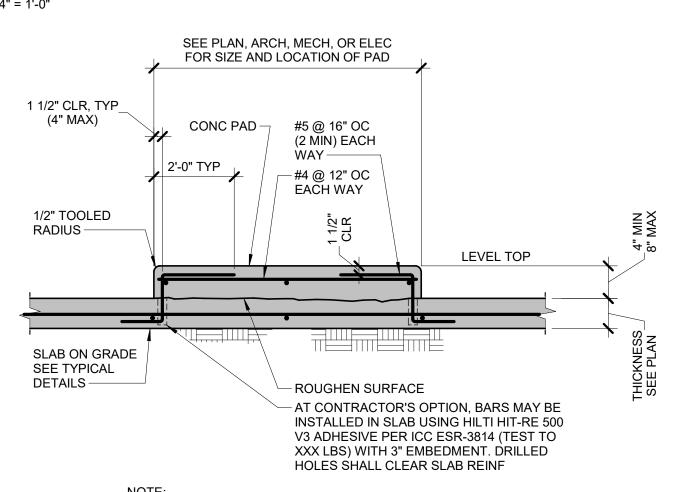
REF. SCALE IN INCHES PROJECT #22002867.01








CHANGE IN SLAB THICKNESS DETAIL 3/4" = 1'-0"

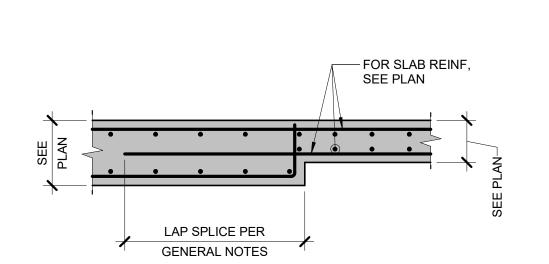

1. SEE ARCHITECTURAL DWGS FOR THE FOLLOWING: A. LOCATION AND DIMENSIONS OF PADS. B. LOCATION AND SIZE OF ANCHOR BOLTS. C. DETAILS OF SUPPORTS, ISOLATORS AND OTHERS.


TYPICAL CONCRETE **EQUIPMENT PAD DETAIL**

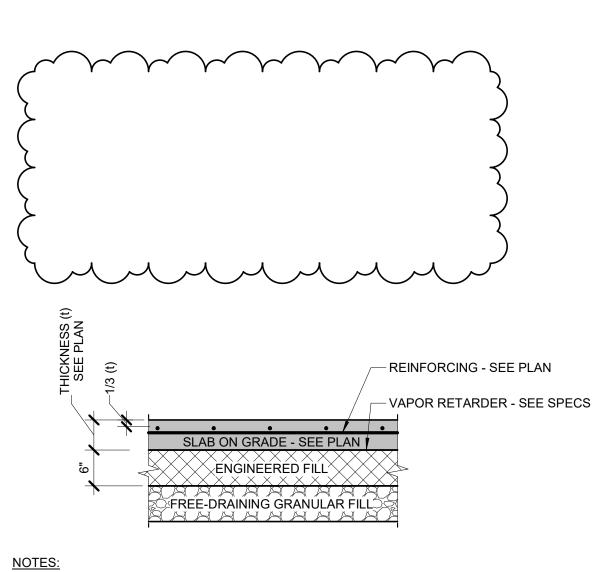


1. REFERENCE SPECIFICATIONS FOR MATERIAL AND COMPACTION REQUIREMENTS.

- 2. COMPACT ALL FILL MATERIAL TO 95% OF THE MAXIMUM DRY DENSITY PER ASTM D1557.
- 3. VAPOR RETARDER TO MEET ASTM E1745, CLASS A AND BE NOT LESS THAN 15 MILS THICK.


TYPICAL SLAB SECTION 3/4" = 1'-0"

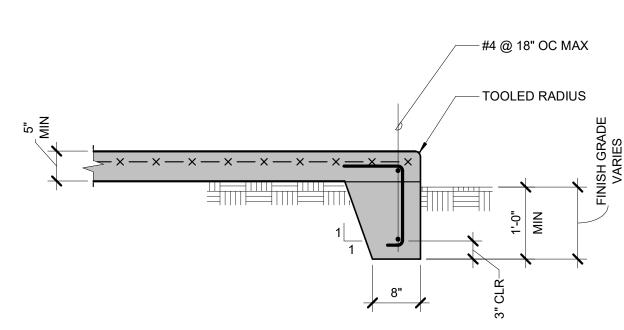


TYPICAL EDGE OF SLAB DETAIL

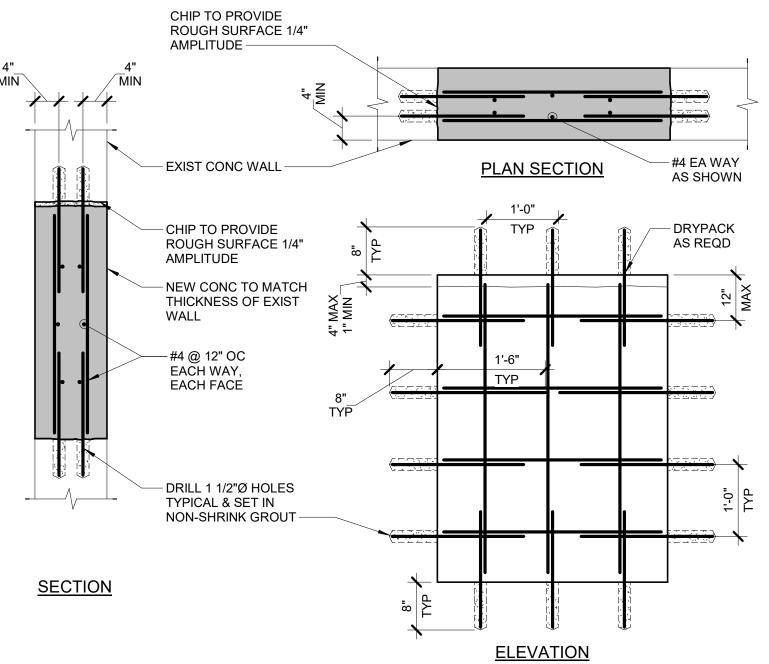


INFILL OF EXISTING OPENING

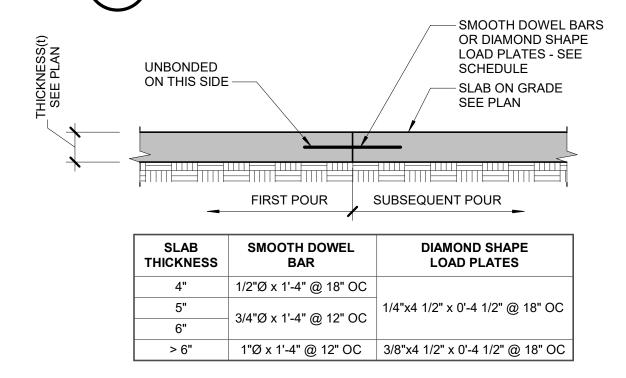


TYPICAL CONSTRUCTION JOINT

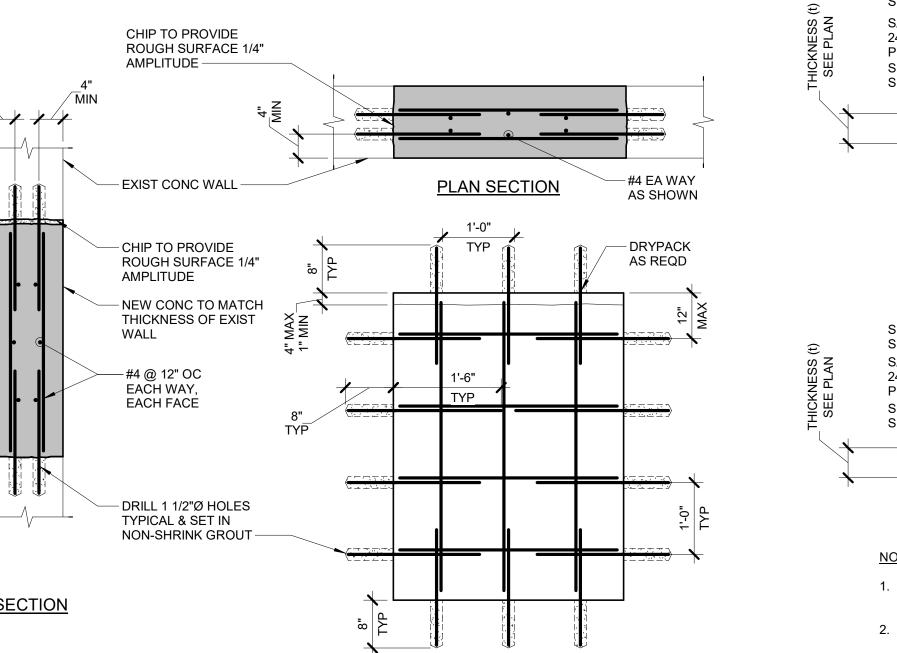

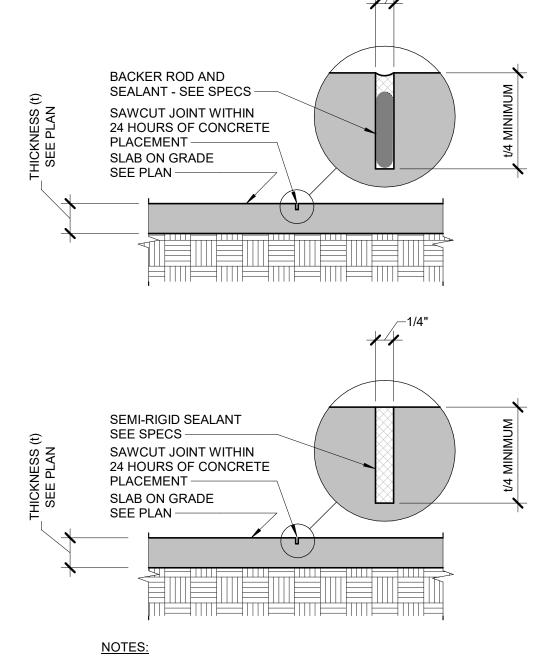

- 1. SEE CAST-IN-PLACE CONCRETE GENERAL NOTES CONCERNING LOCATION OF JOINTS.
- 2. CONTRACTOR MUST OBTAIN WRITTEN APPROVAL PRIOR TO POURING CONCRETE FOR ALL CONSTRUCTION AND/OR CONTROL JOINTS.
- 3. SLAB-ON-GRADE IS A STRUCTURAL DIAPHRAGM AND PART OF LATERAL FORCE RESISTING SYSTEM.


TYPICAL CONTROL JOINT

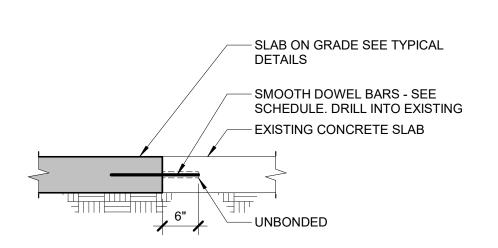

SLAB THICKNESS	SMOOTH DOWEL BAR	
4"	1/2"Ø x 1'-4" @ 18" OC	
5"	3/4"Ø x 1'-4" @ 12" OC	
6"		
> 6"	1"Ø x 1'-4" @ 12" OC	

NEW TO EXISTING SLAB DETAIL

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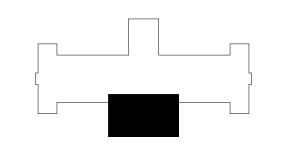
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KEY PLAN

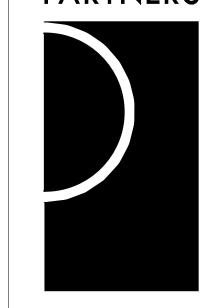

Hamtramck Public Schools

PROJECT NAME

HPS-Hamtramck-MI-Kosciuszko MS

2333 Burger St. Hamtramck, MI 48212

PROJECT NO.

22002867.01

ISSUES / REVISIONS Bidding / Construction 11/17/2022

Addendum No. 1

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APPROVED BY ΑN

SHEET NAME


TYPICAL CONCRETE **DETAILS**

SHEET NO. S301

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MECHANICAL DEMOLITION GENERAL NOTES:

- 1. ANY INTERRUPTION OF EXISTING SERVICES AND/OR EQUIPMENT SHALL BE PERFORMED AT A TIME APPROVED IN ADVANCE BY THE OWNER'S REPRESENTATIVE.
- 2. THESE DRAWINGS ARE DIAGRAMMATIC AND INDICATE THE GENERAL EXTENT OF THE WORK. ACTUAL ROUTING AND SIZES OF EXISTING PIPING AND DUCTWORK MIGHT DIFFER TO A LIMITED EXTENT FROM WHAT IS SHOWN. MAJOR DISCREPANCIES BETWEEN THE DRAWINGS AND ACTUAL EXISTING CONDITIONS SHALL BE REPORTED TO THE ENGINEER.
- 3. THE EXACT EXTENT OF DEMOLITION SHALL BE AS REQUIRED BY THE NEW WORK.
- 4. ALL MECHANICAL ITEMS TO BE REMOVED SHALL BE REMOVED COMPLETE, INCLUDING ALL RELATED ITEMS SUCH AS HANGERS, SUPPORTS, CONTROLS, ETC. CAP ALL OPEN ENDED PIPES AND DUCTWORK.

ELECTRICAL DEMOLITION GENERAL NOTES:

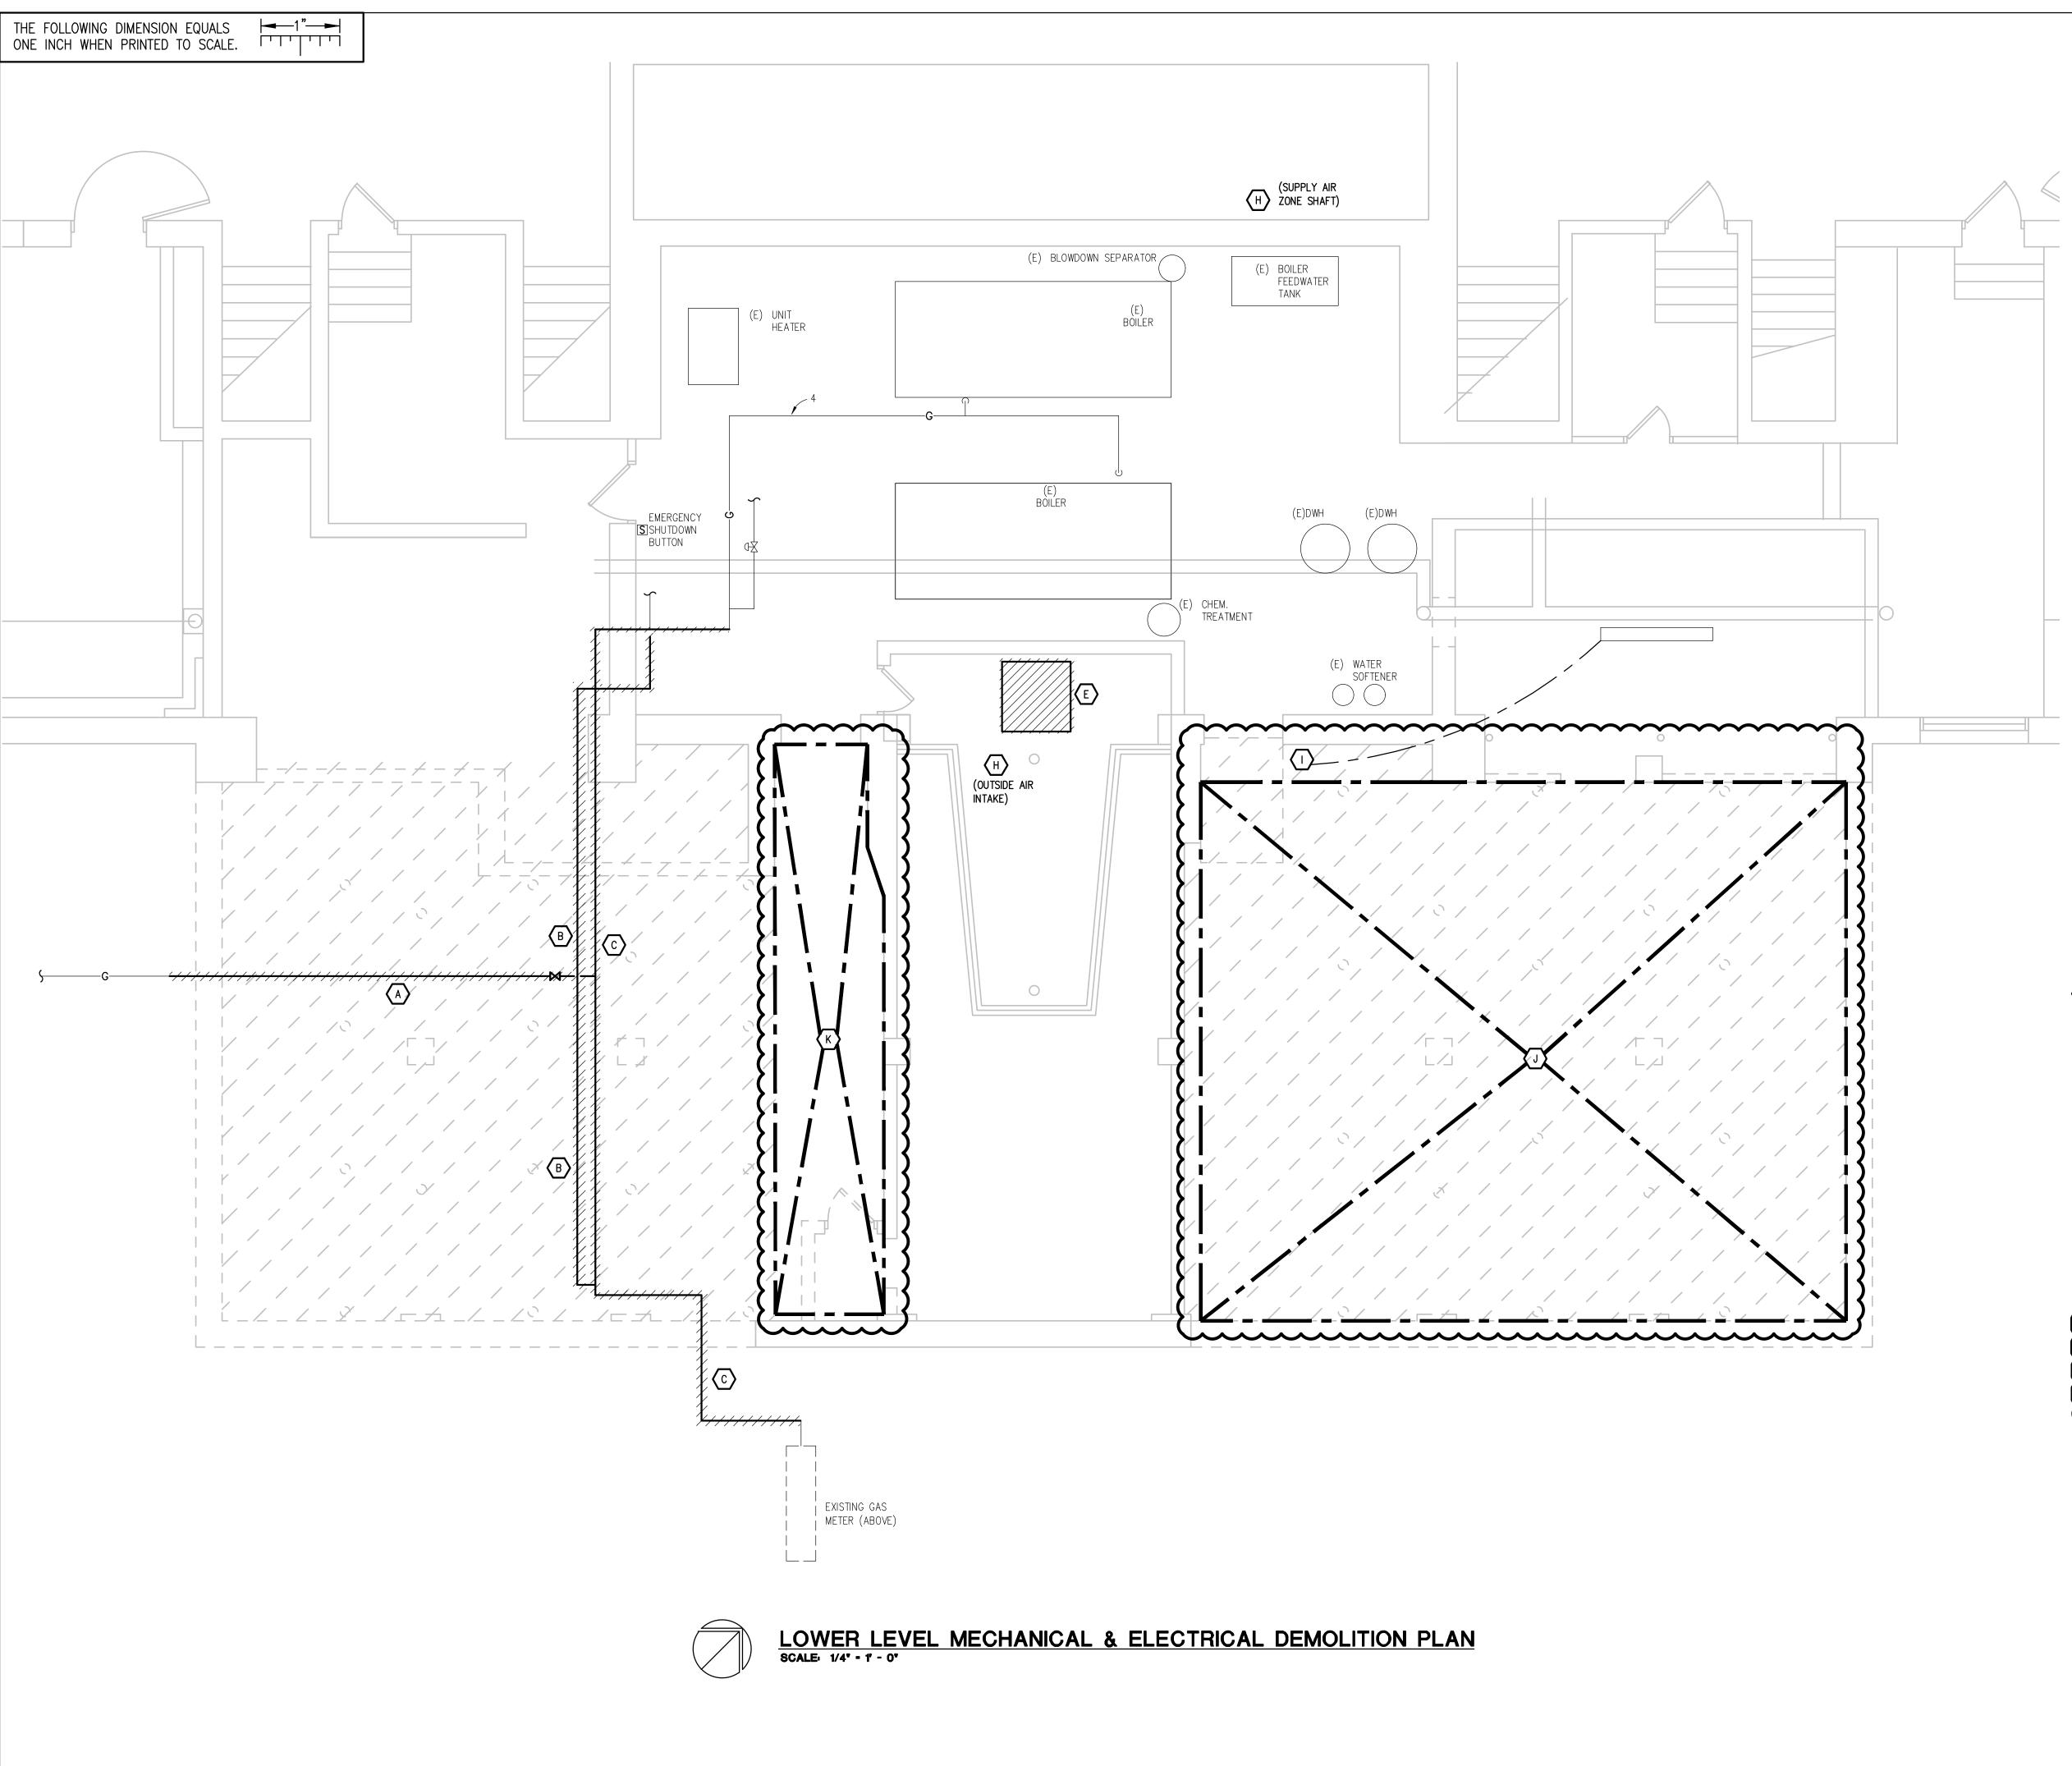EQUIPMENT AND SYSTEMS IN CEILING SPACES.

- VISIT THE SITE PRIOR TO SUBMISSION OF BID TO EXAMINE THE EXISTING CONDITIONS AND THE EXTENT OF DEMOLITION WORK.
- 2. EXAMINE THE DRAWINGS OF OTHER TRADES AND BE FAMILIAR WITH THE DEMOLITION REQUIRED BY OTHER TRADES. PERFORM ALL INCIDENTAL ELECTRICAL DEMOLITION AND/OR RELOCATION REQUIRED TO FACILITATE THE DEMOLITION WORK OF OTHER TRADES, WHETHER OR NOT SPECIFICALLY INDICATED.
- 3. REMOVE EQUIPMENT OR MATERIALS AS INDICATED ON PLAN WITH CROSS HATCHING. DEMOLITION SHALL INCLUDE, BUT NOT BE LIMITED TO, THOSE COMPONENTS SHOWN.
- 4. COORDINATE WITH NEW WORK PLANS, ONE LINE DIAGRAMS AND RISER DIAGRAMS FOR EXTENT OF DEMOLITION WORK.
- 5. PROVIDE PROPER SUPPORT FOR EXISTING TO REMAIN CONDUITS AND BOXES WHERE EXISTING SUPPORT IS TO BE REMOVED. RE—ROUTE BRANCH CIRCUIT CONDUITS AND RELOCATE JUNCTION BOXES AS REQUIRED TO FACILITATE INSTALLATION OF NEW
- 6. REMOVE ALL CONDUIT AND WIRE BACK TO THE SOURCE OR NEAREST UPSTREAM DEVICE REMAINING IN SERVICE.
- 7. MAINTAIN ELECTRICAL SERVICE TO ALL LIGHTING FIXTURES, DEVICES AND EQUIPMENT THAT ARE TO REMAIN. EXTEND CONDUIT AND WIRE AS REQUIRED WHERE DEMOLITION WORK AFFECTS ELECTRICAL SERVICE TO DOWNSTREAM LOADS THAT ARE TO REMAIN.
- 8. DISPOSE OF ALL MATERIALS OFF SITE AND INCLUDE ALL COSTS FOR DISPOSAL IN BID. ALL MATERIALS SHALL BE DISPOSED OF IN ACCORDANCE WITH ALL FEDERAL, STATE, AND LOCAL REGULATIONS, INCLUDING TCLP TESTING, PROPER DISPOSAL AND/OR RECYCLING OF FLUORESCENT LAMPS.
- 9. PROVIDE BLANK COVER PLATES WHERE SWITCHES AND DEVICES ARE REMOVED BUT EXISTING WALLS REMAIN INTACT.
- 10. RING OUT AND TAG ALL CIRCUITS AFFECTED BY THIS ALTERATION AT BOTH ENDS. MARK ALL UNUSED CIRCUIT BREAKERS "SPARE".
- 11. PROVIDE UPDATED TYPED—IN DIRECTORIES FOR ALL PANELS AFFECTED BY THIS ALTERATION.
- 12. VERIFY ALL UNDERGROUND AND IN SLAB UTILITY LOCATIONS PRIOR TO SAW-CUTTING OR PENETRATING ANY FLOOR SLAB.
- 13. COORDINATE ANY SHUT DOWN OF EXISTING SERVICES AND EQUIPMENT THAT ARE REMAINING IN USE WITH THE OWNER'S REPRESENTATIVE. WHERE EXISTING BUILDING SERVICE IS REQUIRED TO BE SHUT DOWN, INCLUDE ALL ASSOCIATED OVERTIME COSTS TO PERFORM THIS WORK DURING WEEKENDS AND EVENINGS INCLUDE ALL COSTS FOR PROVIDING TEMPORARY POWER WHERE SHUT DOWNS MUST OCCUR FOR PERIODS LONGER THAN THESE HOURS. COORDINATE ELECTRICAL SHUT DOWNS WITH THE OWNER 72 HOURS PRIOR TO SHUT DOWN.

(#) DEMOLITION KEY NOTES:

- A. REMOVE SECTION OF 2 GAS PIPE IN ROOM TO BE INFILLED. PREPARE EACH END OF PIPING FOR NEW WORK.
- B. REMOVE SECTION OF 1 GAS PIPING IN ROOM TO BE INFILLED. PREPARE EACH END OF PIPING FOR NEW WORK.
- C. REMOVE SECTION OF 4 GAS PIPING IN ROOM TO BE INFILLED. PREPARE EACH END OF PIPING FOR NEW WORK.
- D. TRENCH AREA FOR INSTALLATION OF NEW GAS LINES.
- E. REMOVE ABANDONED DUCTWORK.


PANELS. SEE ARCHITECTURAL.

- F. REMOVE 48 x 55 LOUVER, DAMPER AND ASSOCIATED LINKAGE. SALVAGE ACTUATOR FOR RE-INSTALLATION. PREPARE CONTROL SIGNAL FOR NEW WORK. PREPARE CONDUIT FOR RELOCATION/NEW WORK. PREPARE OPENING FOR NEW WORK.
- G. REMOVE (4) 36 x 55 LOUVERS, DAMPERS, LINKAGE AND ACTUATORS COMPLETE. PREPARE CONTROL SIGNAL FOR NEW WORK. PREPARE OPENING FOR NEW WORK.
- H. PROVIDE PRE-DEMOLITION SUPPLY AND OUTSIDE AIR FLOW READING FOR MAIN AIR
- HANDLING UNIT. REPORT FINDINGS BACK TO ENGINEER.

 RELOCATE SWITCH AND ASSOCIATED BRANCH CIRCUIT FOR EXISTING LIGHT FIXTURE
- IN STORAGE ROOM. SEE NEW PLANS.
- REMOVE ALL ELECTRICAL DEVICES (POWER, LIGHTING, ETC...) IN THIS ROOM
- COMPLETE (BACK TO SOURCE).

 CIRCUITING AND LIGHTING TO BE MAINTAINED. TEMPORARILY REMOVE AND RE—INSTALL ANY CONDUIT AND LIGHT FIXTURES FOR FACILITATION OF NEW CEILING

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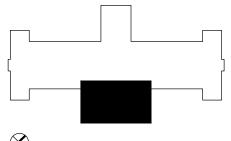
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CONSULTANT

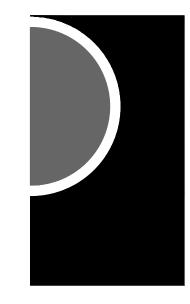

Troy, Michigan 48098-3276 Tel: 248-879-5666 Fax: 248-879-0007 www.PeterBassoAssociates.com PBA Project No.: 2022.0160

KEY PLAN



Hamtramck

Public Schools

PROJECT NAME

School

Kosciuszko Middle

Structural Repairs

2333 Burger St. Hamtramck, MI 48212

PROJECT NO.

21-167

ISSUES / REVISIONS

Bidding / Construction 11/17/2022

Addendum #1 12/6/2022

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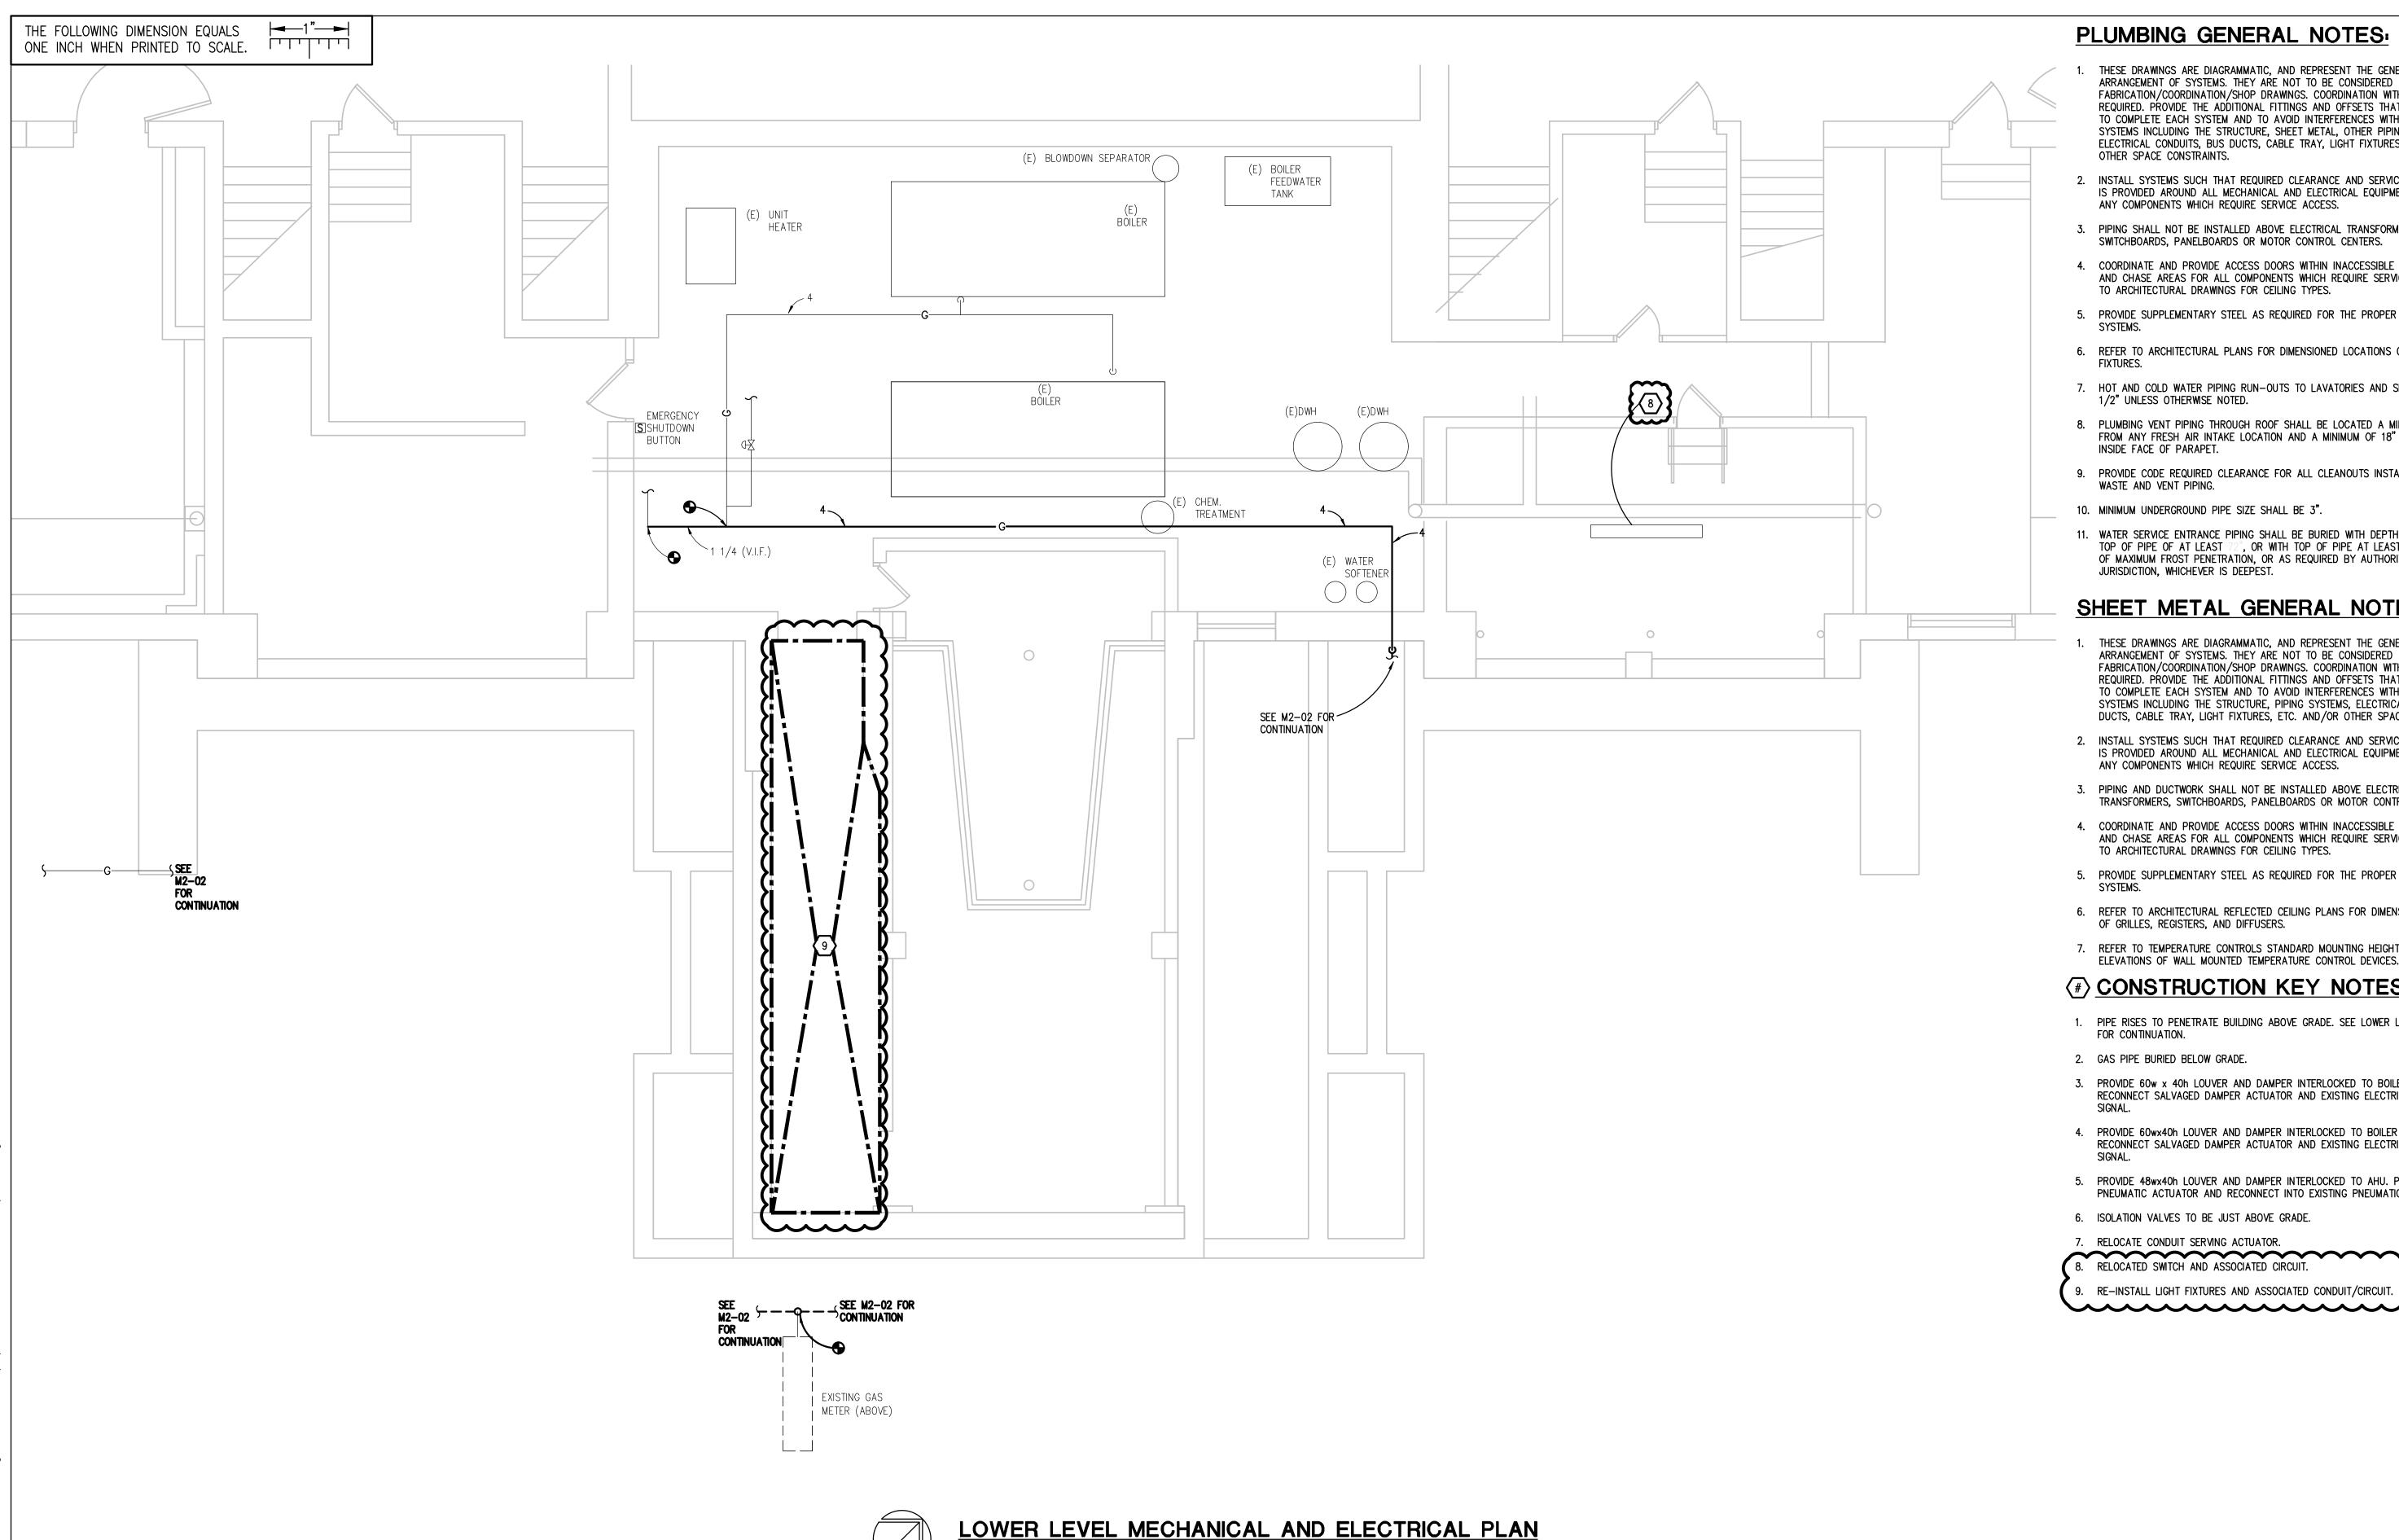
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SVM
SHEET NAME
LOWER LEVEL MECHA

LOWER LEVEL MECHANICAL &
ELECTRICAL DEMOLITION PLAN

SHEET NO. MED2-01



SCALE: 1/4" - 1' - 0"

PLUMBING GENERAL NOTES:

- THESE DRAWINGS ARE DIAGRAMMATIC, AND REPRESENT THE GENERAL INTENT AND ARRANGEMENT OF SYSTEMS. THEY ARE NOT TO BE CONSIDERED FABRICATION/COORDINATION/SHOP DRAWINGS. COORDINATION WITH OTHER TRADES IS REQUIRED. PROVIDE THE ADDITIONAL FITTINGS AND OFFSETS THAT WILL BE REQUIRED TO COMPLETE EACH SYSTEM AND TO AVOID INTERFERENCES WITH ALL OTHER SYSTEMS INCLUDING THE STRUCTURE, SHEET METAL, OTHER PIPING SYSTEMS, ELECTRICAL CONDUITS, BUS DUCTS, CABLE TRAY, LIGHT FIXTURES, ETC. AND/OR OTHER SPACE CONSTRAINTS.
- 2. INSTALL SYSTEMS SUCH THAT REQUIRED CLEARANCE AND SERVICE ACCESS SPACE IS PROVIDED AROUND ALL MECHANICAL AND ELECTRICAL EQUIPMENT, AND AROUND ANY COMPONENTS WHICH REQUIRE SERVICE ACCESS.
- 3. PIPING SHALL NOT BE INSTALLED ABOVE ELECTRICAL TRANSFORMERS, SWITCHBOARDS, PANELBOARDS OR MOTOR CONTROL CENTERS.
- 4. COORDINATE AND PROVIDE ACCESS DOORS WITHIN INACCESSIBLE CEILING, SHAFT, AND CHASE AREAS FOR ALL COMPONENTS WHICH REQUIRE SERVICE ACCESS. REFER TO ARCHITECTURAL DRAWINGS FOR CEILING TYPES.
- 5. PROVIDE SUPPLEMENTARY STEEL AS REQUIRED FOR THE PROPER SUPPORT OF ALL
- 6. REFER TO ARCHITECTURAL PLANS FOR DIMENSIONED LOCATIONS OF PLUMBING
- 7. HOT AND COLD WATER PIPING RUN-OUTS TO LAVATORIES AND SINKS SHALL BE 1/2" UNLESS OTHERWISE NOTED.
- 8. PLUMBING VENT PIPING THROUGH ROOF SHALL BE LOCATED A MINIMUM OF 10'-0" FROM ANY FRESH AIR INTAKE LOCATION AND A MINIMUM OF 18" CLEAR FROM THE INSIDE FACE OF PARAPET.
- 9. PROVIDE CODE REQUIRED CLEARANCE FOR ALL CLEANOUTS INSTALLED IN SANITARY WASTE AND VENT PIPING.
- 10. MINIMUM UNDERGROUND PIPE SIZE SHALL BE 3".
- 11. WATER SERVICE ENTRANCE PIPING SHALL BE BURIED WITH DEPTH OF COVER OVER TOP OF PIPE OF AT LEAST 72", OR WITH TOP OF PIPE AT LEAST 12" BELOW LEVEL OF MAXIMUM FROST PENETRATION, OR AS REQUIRED BY AUTHORITIES HAVING JURISDICTION, WHICHEVER IS DEEPEST.


SHEET METAL GENERAL NOTES:

- THESE DRAWINGS ARE DIAGRAMMATIC, AND REPRESENT THE GENERAL INTENT AND ARRANGEMENT OF SYSTEMS. THEY ARE NOT TO BE CONSIDERED FABRICATION/COORDINATION/SHOP DRAWINGS. COORDINATION WITH OTHER TRADES IS REQUIRED. PROVIDE THE ADDITIONAL FITTINGS AND OFFSETS THAT WILL BE REQUIRED TO COMPLETE EACH SYSTEM AND TO AVOID INTERFERENCES WITH ALL OTHER SYSTEMS INCLUDING THE STRUCTURE, PIPING SYSTEMS, ELECTRICAL CONDUITS, BUS DUCTS, CABLE TRAY, LIGHT FIXTURES, ETC. AND/OR OTHER SPACE CONSTRAINTS.
- 2. INSTALL SYSTEMS SUCH THAT REQUIRED CLEARANCE AND SERVICE ACCESS SPACE IS PROVIDED AROUND ALL MECHANICAL AND ELECTRICAL EQUIPMENT, AND AROUND ANY COMPONENTS WHICH REQUIRE SERVICE ACCESS.
- 3. PIPING AND DUCTWORK SHALL NOT BE INSTALLED ABOVE ELECTRICAL TRANSFORMERS, SWITCHBOARDS, PANELBOARDS OR MOTOR CONTROL CENTERS.
- 4. COORDINATE AND PROVIDE ACCESS DOORS WITHIN INACCESSIBLE CEILING, SHAFT, AND CHASE AREAS FOR ALL COMPONENTS WHICH REQUIRE SERVICE ACCESS. REFER TO ARCHITECTURAL DRAWINGS FOR CEILING TYPES.
- 5. PROVIDE SUPPLEMENTARY STEEL AS REQUIRED FOR THE PROPER SUPPORT OF ALL
- 6. REFER TO ARCHITECTURAL REFLECTED CEILING PLANS FOR DIMENSIONED LOCATION OF GRILLES, REGISTERS, AND DIFFUSERS.
- 7. REFER TO TEMPERATURE CONTROLS STANDARD MOUNTING HEIGHTS DETAIL FOR ELEVATIONS OF WALL MOUNTED TEMPERATURE CONTROL DEVICES.

CONSTRUCTION KEY NOTES:

- 1. PIPE RISES TO PENETRATE BUILDING ABOVE GRADE. SEE LOWER LEVEL PLAN M2-01
- 2. GAS PIPE BURIED BELOW GRADE.
- 3. PROVIDE 60w x 40h LOUVER AND DAMPER INTERLOCKED TO BOILER No 1. RECONNECT SALVAGED DAMPER ACTUATOR AND EXISTING ELECTRIC CONTROL
- 4. PROVIDE 60wx40h LOUVER AND DAMPER INTERLOCKED TO BOILER No. 2. RECONNECT SALVAGED DAMPER ACTUATOR AND EXISTING ELECTRIC CONTROL
- 5. PROVIDE 48wx40h LOUVER AND DAMPER INTERLOCKED TO AHU. PROVIDE NEW PNEUMATIC ACTUATOR AND RECONNECT INTO EXISTING PNEUMATIC CONTROL SIGNAL.
- 6. ISOLATION VALVES TO BE JUST ABOVE GRADE.
- 7. RELOCATE CONDUIT SERVING ACTUATOR.
- 8. RELOCATED SWITCH AND ASSOCIATED CIRCUIT.
- 9. RE-INSTALL LIGHT FIXTURES AND ASSOCIATED CONDUIT/CIRCUIT.

PARTNERS

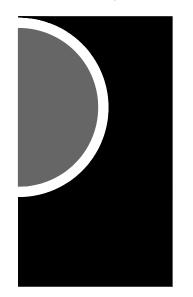

PARTNERS in Architecture, PLC 65 MARKET STREET MOUNT CLEMENS, MI 48043

Statement of Intellectual Property

P 586.469.3600

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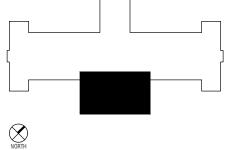
THIS DRAWING IS NOT TO BE USED FOR CONSTRUCTION UNI ESS ISSUED BELOV SPECIFICALLY FOR "BIDDING / CONSTRUCTION"

CONSULTANT



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KEY PLAN



Hamtramck Public Schools

PROJECT NAME

Kosciuszko Middle School

2333 Burger St.

Structural Repairs

Hamtramck, MI 48212

PROJECT NO.

21-167

ISSUES / REVISIONS Bidding / Construction 11/17/2022 Addendum #1

DRAWN BY

CHECKED BY

APPROVED BY

SHEET NAME

LOWER LEVEL MECHANICAL AND ELECTRICAL PLAN

SHEET NO. ME2-01